# SKAGIT COUNTY PARKS AND RECREATION SKAGIT FIELDS

#### PROJECT INFORMATION

1. PROJECT NAME: SKAGIT FIELDS

2. OWNER: SKAGIT COUNTY PARKS AND RECREATION 1730 CONTINENTAL PLACE MOUNT VERNON, WA, 98273 360-416-1356 BRIAN ADAMS

3. CIVIL ENGINEER: REID MIDDLETON 728 134TH ST SW, SUITE 200 EVERETT WA 98204 425-741-3800 JEFF JENKS

4. SURVEYOR: REID MIDDLETON 728 134TH ST SW, SUITE 200 EVERETT WA 98204 425-741-3800 ROB MCCABE

5. LANDSCAPE ARCHITECT: ECCOS DESIGN LLC 505 SOUTH FIRST STREET MOUNT VERNON, WA, 98273 360-419-7400 PATRIK DYLAN, PLA

6. ENVIRONMENTAL LAND USE: GRAHAM-BUNTING ASSOCIATES 3643 LEGG ROAD BOW, WA 98232 360-766-4441 PATRICIA BUNTING OSCAR GRAHAM

7. CITY OF MOUNT VERNON INSPECTIONS: 360-336-6243 PUBLIC WORKS: 360-336-6204 DEVELOPMENT SERVICES: 360-336-6214

## SITE INFORMATION

SITE ADDRESS: 2801 EAST COLLEGE WAY PARCEL NUMBERS: P25048, P25050, P25052, P25055

ZONING:

24.06 ACRES (SUM OF SUBJECT PARCELS) PROPERTY AREA: WORK AREA: 11 ACRES

SITE DESIGN BASED ON RECORD DRAWINGS, ASSESSORS MAPPING, WETLAND SURVEY AND AERIAL PHOTOGRAPHY

#### REFERENCE PERMITS CITY OF MOUNT VERNON

SEPA: PLAN20-0184 CRITICAL AREAS: PLAN20-0185

TRAFFIC CONCURRENCY: ENGR20-0133 FILL AND GRADE: ENGR21-0255

U.S. ARMY CORPS OF ENGINEERS

NWS-2018-1164


WA STATE DEPARTMENT OF ECOLOGY

WATER QUALITY CERTIFICATION ORDER #19504

NPDES CONSTRUCTION STORMWATER GENERAL PERMIT #WAR312431

# MOUNT VERNON, WASHINGTON

NW SECTION 16, TOWNSHIP 34, RANGE 4E, W.M.

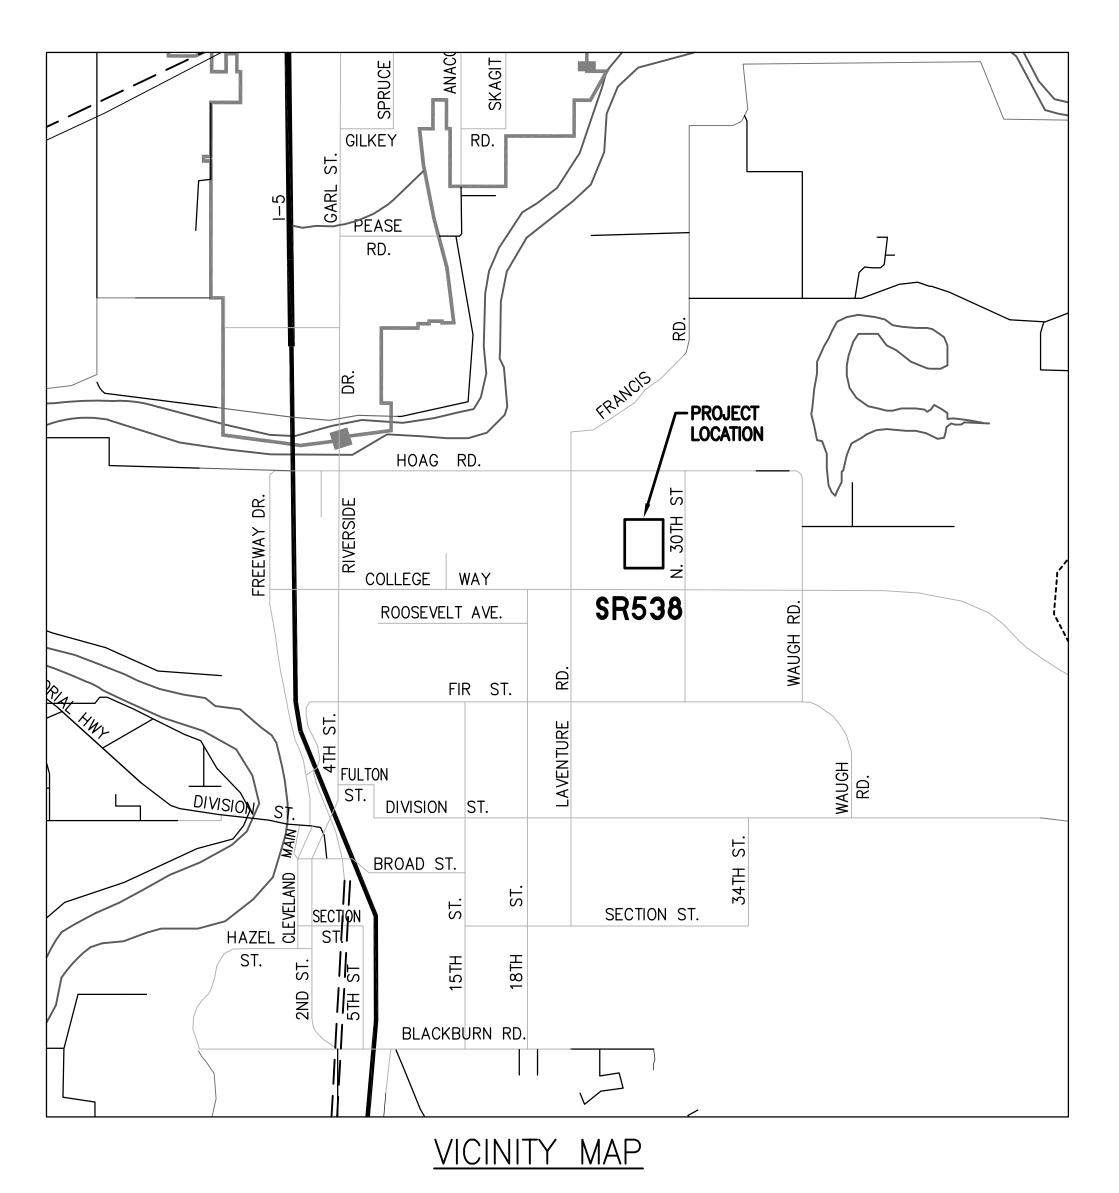

# SHEET INDEX

SHEET	TITLE
C1.0	COVER SHEET
V1.0	EXISTING CONDITIONS
V1.1	EXISTING CONDITIONS
V1.2	EXISTING CONDITIONS
C1.1	EXISTING WETLANDS
C1.2	DEMOLITION AND CLEARING AND TEMPORARY EROSION AND SEDIMENT CONTROL PLAN
C1.3	DEMOLITOIN AND CLEARING AND TEMPORARY EROSION AND SEDIMENT CONTROL PLAN
C1.4	FIELD LAYOUT PLAN
C1.5	FIELD LAYOUT PLAN
C2.0	GRADING AND DRAINAGE PLAN
C2.1	GRADING AND DRAINAGE PLAN
C2.2	GENERAL NOTES
C2.3	DETAILS
C3.0	MATERIALS PLAN
C3.1	MATERIALS PLAN


#### **GENERAL CONSTRUCTION REQUIREMENTS**

ALL WORK AND MATERIAL SHALL CONFORM TO THE 2020 WASHINGTON STATE DEPARTMENT OF TRANSPORTATION STANDARD SPECIFICATIONS AND CURRENT WASHINGTON STATE DEPARTMENT OF TRANSPORTATION STANDARD PLANS FOR ROAD, BRIDGE AND MUNICIPAL CONSTRUCTION.

#### **SUBMITTAL NOTES:**

SUBMIT THE FOLLOWING TO SKAGIT COUNTY PARKS REPRESENTATIVE:

- 1. EROSION CONTROL SUBMITTALS LISTED ON SHEETS C1.2 AND C1.3.
- STORM DRAINAGE SUBMITTALS LISTED ON SHEET C2.1.
- HAVE TOPSOIL IN 'FIELD' AREA TESTED BY A CERTIFIED SOIL TESTING LABORATORY TO DETERMINE THE TYPE AND QUANTITY OF SOIL AMENDMENTS NECESSARY AS PART OF AMENDMENT FERTILIZER. THREE SEPARATE LOCATIONS AT LEAST 100 FEET APART ARE TO BE TESTED. REVIEW WITH OWNER ADEQUACY OF SPECIFIED AMENDMENT FERTILIZER.
- SIEVE ANALYSIS OF IMPORTED ASTM C-33 DRAINAGE SAND
- CERTIFICATION OF GRASS SEED FROM VENDOR.
- SUBMIT LIST OF MACHINERY TO BE USED DURING SUBGRADE PREPARATION AND TOPSOILING OPERATIONS. NO RUBBER TIRED MACHINERY WILL BE PERMITTED EXCEPT FOR LIGHT-WEIGHT, FARM TRACTOR GRADE MACHINERY WITH WIDE TIRES DESIGNED FOR TURF USE. ALL HEAVY MACHINERY MUST BE TRACK DRIVEN.

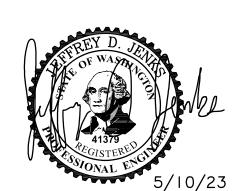

**CALL 48 HOURS BEFORE YOU DIG** 811

IF "L" DOES NOT MEASURE 1" ADJUST SCALES ACCORDINGLY.

1"=60' DES. JDJ SHEET NO. OATE 05/10/2023

FILE 21-2018-016

#### LIGHT POLE ——— P ——— POWER LINE POWER POLE WITH LIGHT OVERHEAD POWER LINE PVLT COMMUNICATIONS LINE POWER VAULT ELECTRICAL HAND HOLE WATER LINE COMMUNICATIONS VAULT — G — GAS LINE COMMUNICATIONS HAND HOLE SANITARY SEWER LINE FIRE HYDRANT ----- SD ------ STORM DRAIN LINE SANITARY SEWER MANHOLE DITCH CENTERLINE STORM CATCH BASIN — X — X — CHAINLINK FENCE CULVERT ANNING LINE MAG NAIL & WASHER SURVEY MARKER DECIDUOUS TREE

CONIFER TREE

200 100 0 200 400

SCALE IN FEET

ELEV= 74.33

ELEV= 76.72

**LEGAL DESCRIPTION:** 

P25050 PER STATUTORY WARRANTY DEED AFN 9703180075:

THE WEST 5 ACRES OF THE EAST 10 ACRES OF THE SOUTHEAST 1/4 OF THE NORTHWEST 1/4 OF SECTION 16, TOWNSHIP 34 NORTH, RANGE 4 EAST, W.M., EXCEPT COUNTY ROAD ALONG THE SOUTH LINE THEREOF.

SITUATE IN THE COUNTY OF SKAGIT, STATE OF WASHINGTON.

P25048 PER WARRANTY DEED AFN 200506010004:

THE WEST 10 ACRES OF THE EAST 20 ACRES OF THE SOUTHEAST QUARTER OF THE NORTHWEST QUARTER OF SECTION 16, TOWNSHIP 34 NORTH, RANGE 4 EAST W.M., EXCEPT THE RIGHT OF WAY FOR STATE HIGHWAY NO. 539, COMMONLY KNOWN AS COLLEGE WAY, ALONG THE SOUTH LINE THEREOF;

AND EXCEPT THAT PORTION OF SAID PREMISES, IF ANY, LYING WITHIN THE EAST HALF OF THE WEST HALF OF SAID SOUTHEAST QUARTER OF THE NORTHWEST QUARTER;

AND ALSO EXCEPT THAT PORTION CONVEYED TO THE STATE OF WASHINGTON, BY DEED RECORDED AUGUST 14, 1986, UNDER AUDITOR'S FILE NO. 8608140061.

P25055 PER STATUTORY WARRANTY DEED AFN 200708090102:

ALL THAT PART OF THE SOUTHEAST 1/4 OF THE NORTHWEST 1/4 OF SECTION 16, TOWNSHIP 34 NORTH, RANGE 4 EAST, W.M., BEING MORE PARTICULARLY DESCRIBED AS FOLLOWS:

COMMENCING AT THE NORTHEAST CORNER OF SAID SOUTHEAST 1/4 OF THE NORTHWEST 1/4 OF SECTION 16, AS SAID POINT IS SHOWN ON HTAT CERTAIN RECORD OF SURVEY RECORDED IN BOOK 19 OF SURVEYS AT PAGE 185, UNDER AUDITOR'S FILE NO. 9710100068, RECORDS OF SKAGIT COUNTY, WASHINGTON;

THENCE NORTH 88'28'09" WEST ALONG THE NORTH LINE THEREOF, 659.34 FEET TO THE NORTHWEST CORNER OF THE EAST 20 ACRES OF SAID SOUTHEAST 1/4 OF THE NORTHWEST 1/4, SAID POINT BEING THE TRUE POINT OF BEGINNING;

THENCE SOUTH 01°17'43" WEST ALONG THE WEST LINE THEREOF, 679.80 FEET;

THENCE NORTH 88°28'09" WEST PARALLEL WITH SAID LINE NORTH LINE, 159.80 FEET TO THE WEST LINE OF THE EAST 1/2 OF THE EAST 1/2 OF THE WEST 1/2 OF THE SOUTHEAST 1/4 OF THE NORTHWEST 1/4 OF SECTION 16;

THENCE NORTH 01°13'44" EAST ALONG SAID WEST LINE, 679.80 FEET TO SAID NORTH LINE; THENCE SOUTH 88°28'09" EAST ALONG SAID NORTH LINE, 160.59 FEET TO THE TRUE POINT OF BEGINNING;

CONTAINING 2.50 ACRES.

#### SURVEY NOTES:

- 1. SR 538 (COLLEGE WAY) RIGHT-OF-WAY SHOWN BASED UPON WSDOT RIGHT OF WAY PLAN "SR 538 LAVENTURE ROAD TO N. 42ND PL." DATED JANUARY 10, 2002.
- 2. THIS SURVEY WAS MADE WITHOUT THE BENEFIT OF A TITLE REPORT. A BOUNDARY SURVEY WAS NOT COMPLETED IN CONJUNCTION WITH THIS TOPOGRAPHIC SURVEY
- 3. THIS SURVEY WAS COMPLETED IN THE MONTH OF JANUARY, 2022 TO SERVE AS A BASEMAP FOR CONTEMPLATED DESIGN WORK.

#### UTILITY NOTES:

- 1. THE UTILITIES SHOWN HEREON ARE BASED ON FIELD OBSERVATIONS OF SURFACE FEATURES, RECORD UTILITY MAPS/COUNTY G.I.S. SYSTEMS AND BY PAINT MARKS SET BY A UTILITY LOCATING COMPANY. FIELD LOCATIONS MUST BE VERIFIED PRIOR TO ANY CONSTRUCTION.
- 2. UTILITIES MARKED \* ARE AS PER COUNTY (GIS SYSTEM/UTILITY RECORD MAPS/PROJECTS/AS-BUILTS)

<u>F.E.M.A. NOTE</u>

ACCORDING TO FIRM MAP NO. 5301580001B, DATED JANUARY 3, 1985, THE PREMISES SHOWN HEREON LIE WITHIN ZONE "C", DETERMINED TO BE OUTSIDE THE 0.2% ANNUAL CHANCE FLOOD PLANE

#### HORIZONTAL DATUM

NAD83/11, WA STATE PLANE, NORTH ZONE
COORDINATES ESTABLISHED THROUGH GPS RTK OBSERVATIONS
VIA THE WASHINGTON STATE REFERENCE NETWORK, ADDITIONAL
CONTROL COORDINATES WERE ESTABLISHED VIA CLOSED
TRAVERSE

OBSERVED CONTROL POINT POSITIONS:

CONTROL POINT NO. 25000

3" BRASS DISC WITH DRILL HOLE 14" BELOW SURFACE IN CASE AT INTERSECTION OF E COLLEGE WAY (SR 538) AND N 30TH STREET.

NORTHING : 527068.38 EASTING : 1283773.63 ELEVATION : 72.82

CONTROL POINT NO. 25001

2" BRASS DISC WITH "X" 12" BELOW SURFACE IN CASE AT INTERSECTION OF E COLLEGE WAY (SR 538) AND N LAVENTURE ROAD.

NORTHING: 527130.27
EASTING: 1281155.37

ELEVATION : 89.99
VERTICAL DATUM

ERTICAL DATUM

NAVD88

PER FIELD OBSERVATIONS TO THE ABOVE MENTIONED CONTROL POINTS.

CONTROL METHODOLOGY

EQUIPMENT : LEICA GS14 GNSS RECEIVER
METHOD : 3 MINUTE OBSERVATIONS

EQUIPMENT : LEICA MS50 MULTISTATION METHOD : FIELD TRAVERSE

TOPOGRAPHY METHODOLOGY

EQUIPMENT : LEICA MS50 MULTISTATION METHOD : FIELD TRAVERSE

FIELDWORK PERFORMED : NOVEMBER 2021-JANUARY 2022

ROBERT WASTICE WASTICE

# CALL 48 HOURS BEFORE YOU DIG 811

NOTE: |- L - |


IF "L" DOES NOT MEASURE 1'
ADJUST SCALES ACCORDINGLY.


DES. WRM
DR. WRM
CH. \_\_\_\_
F.B. OF SHEETS


DATE FEB 04 2022

FILE 21-2018-016

55

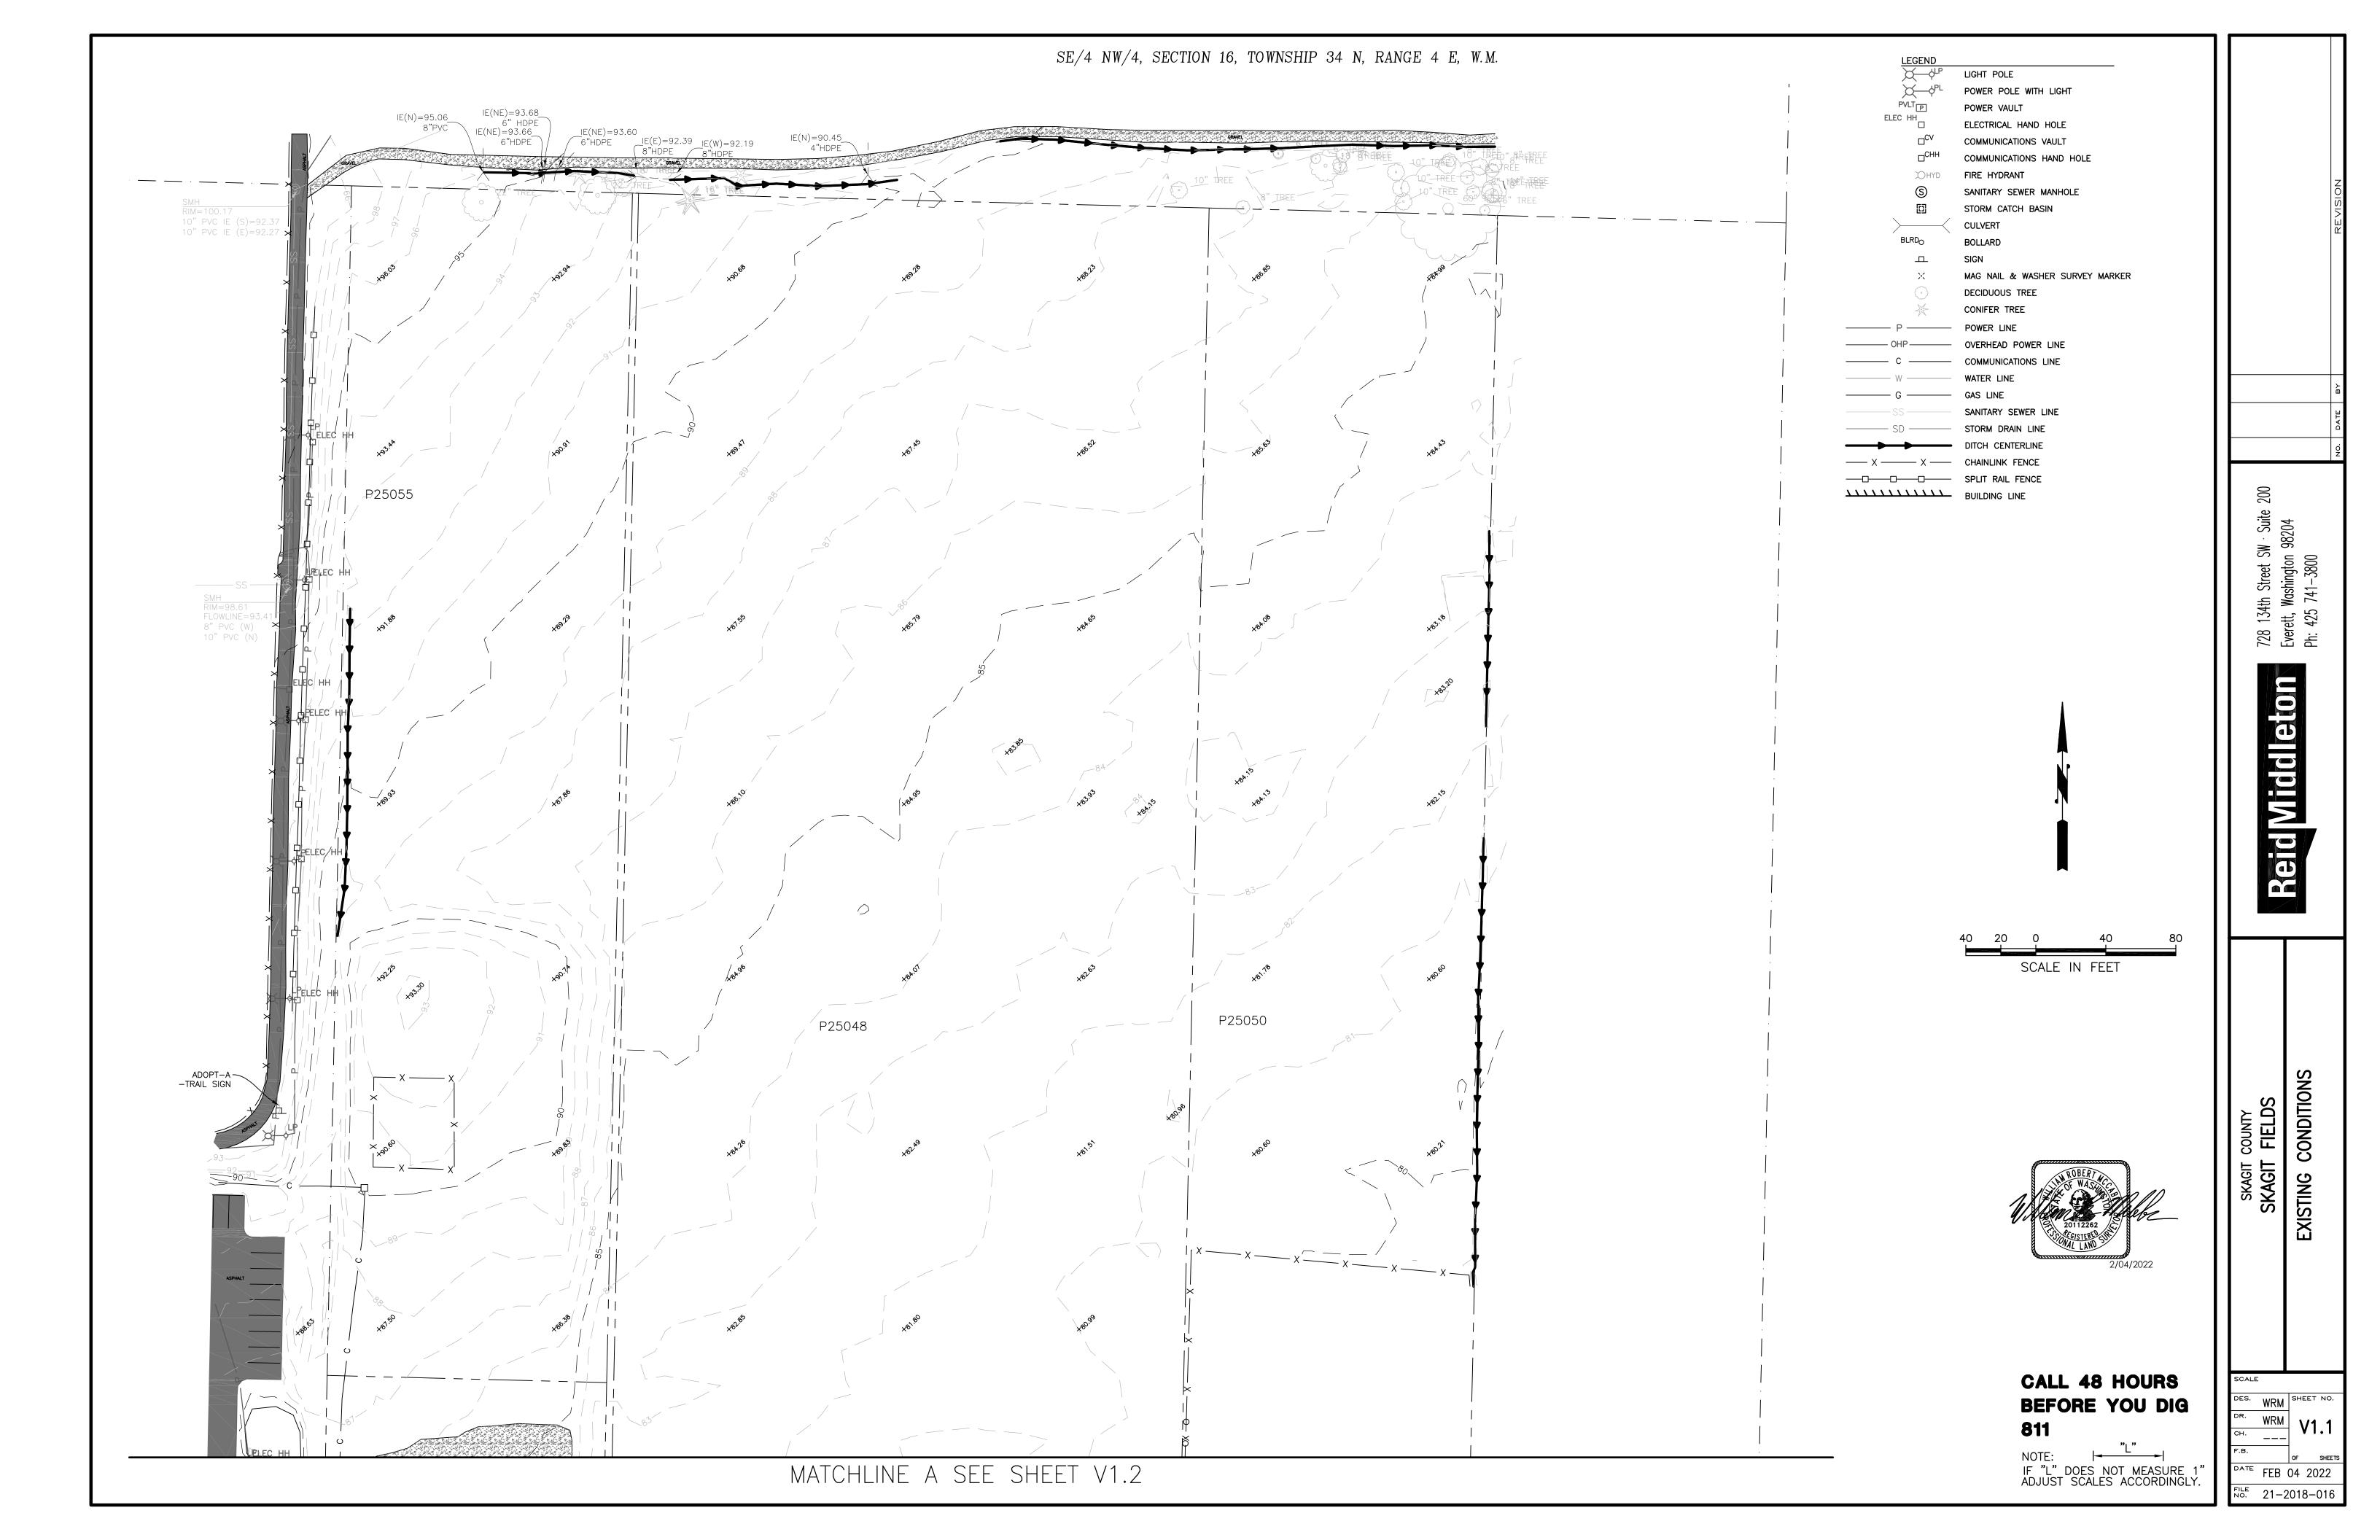

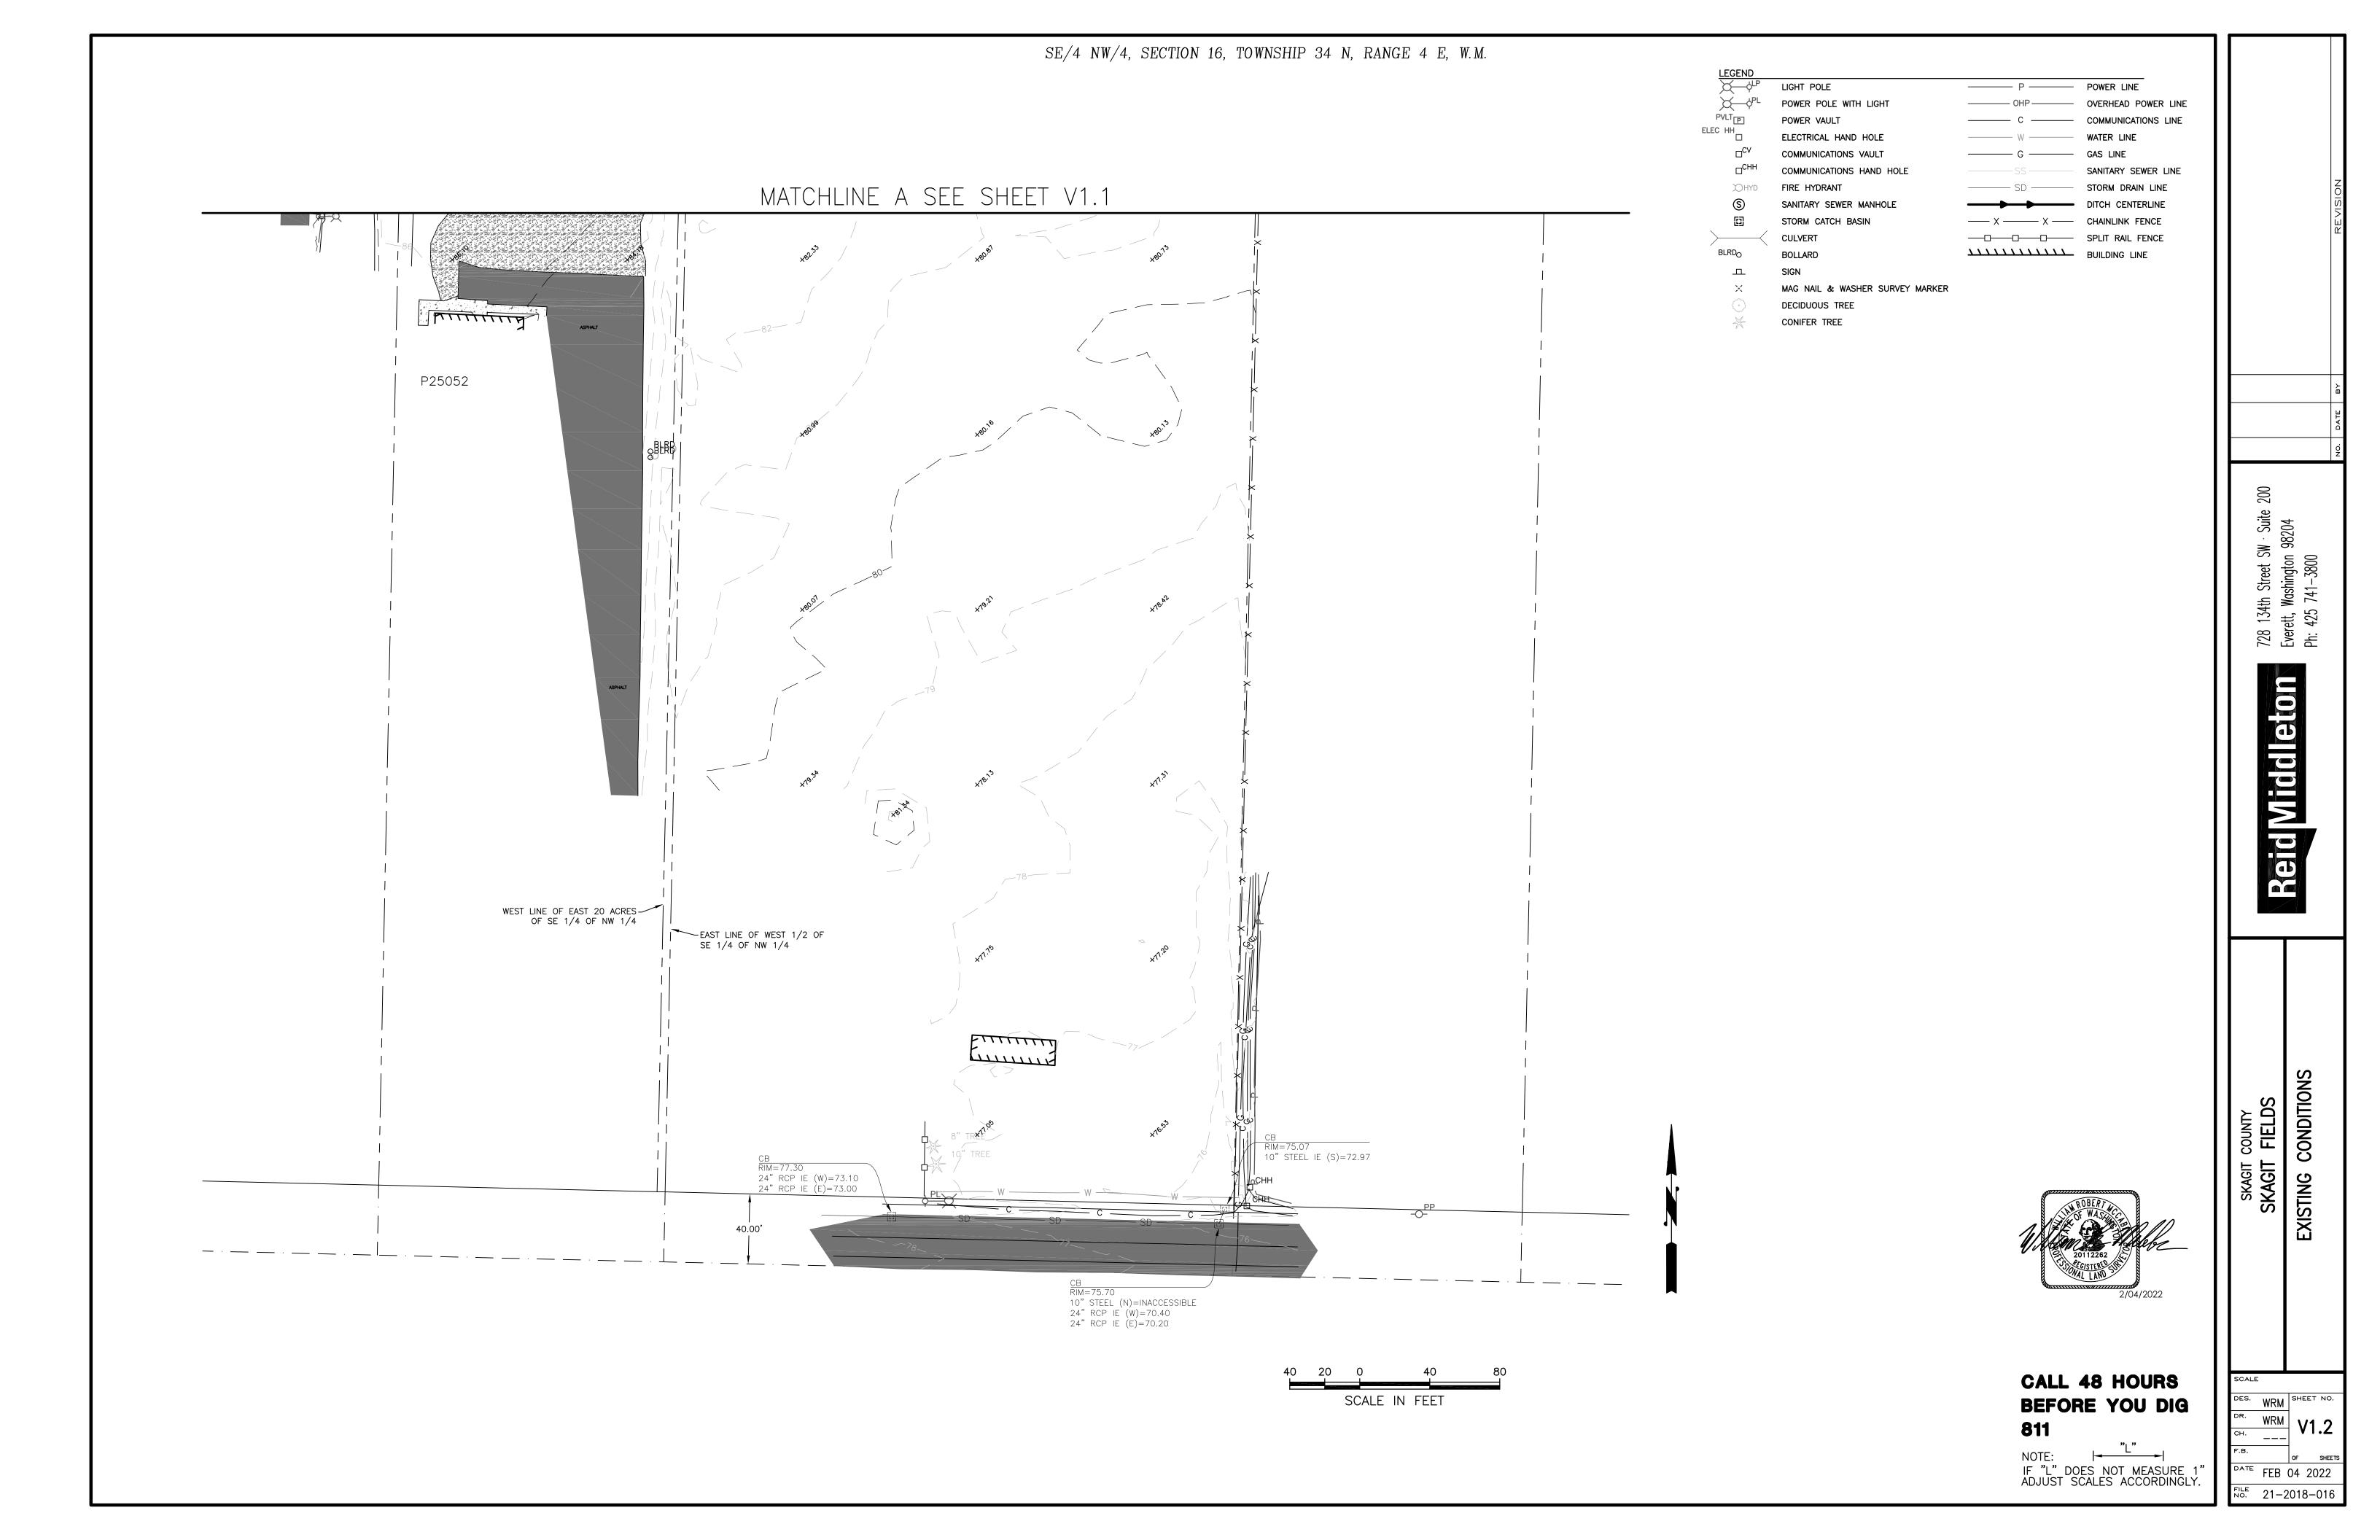

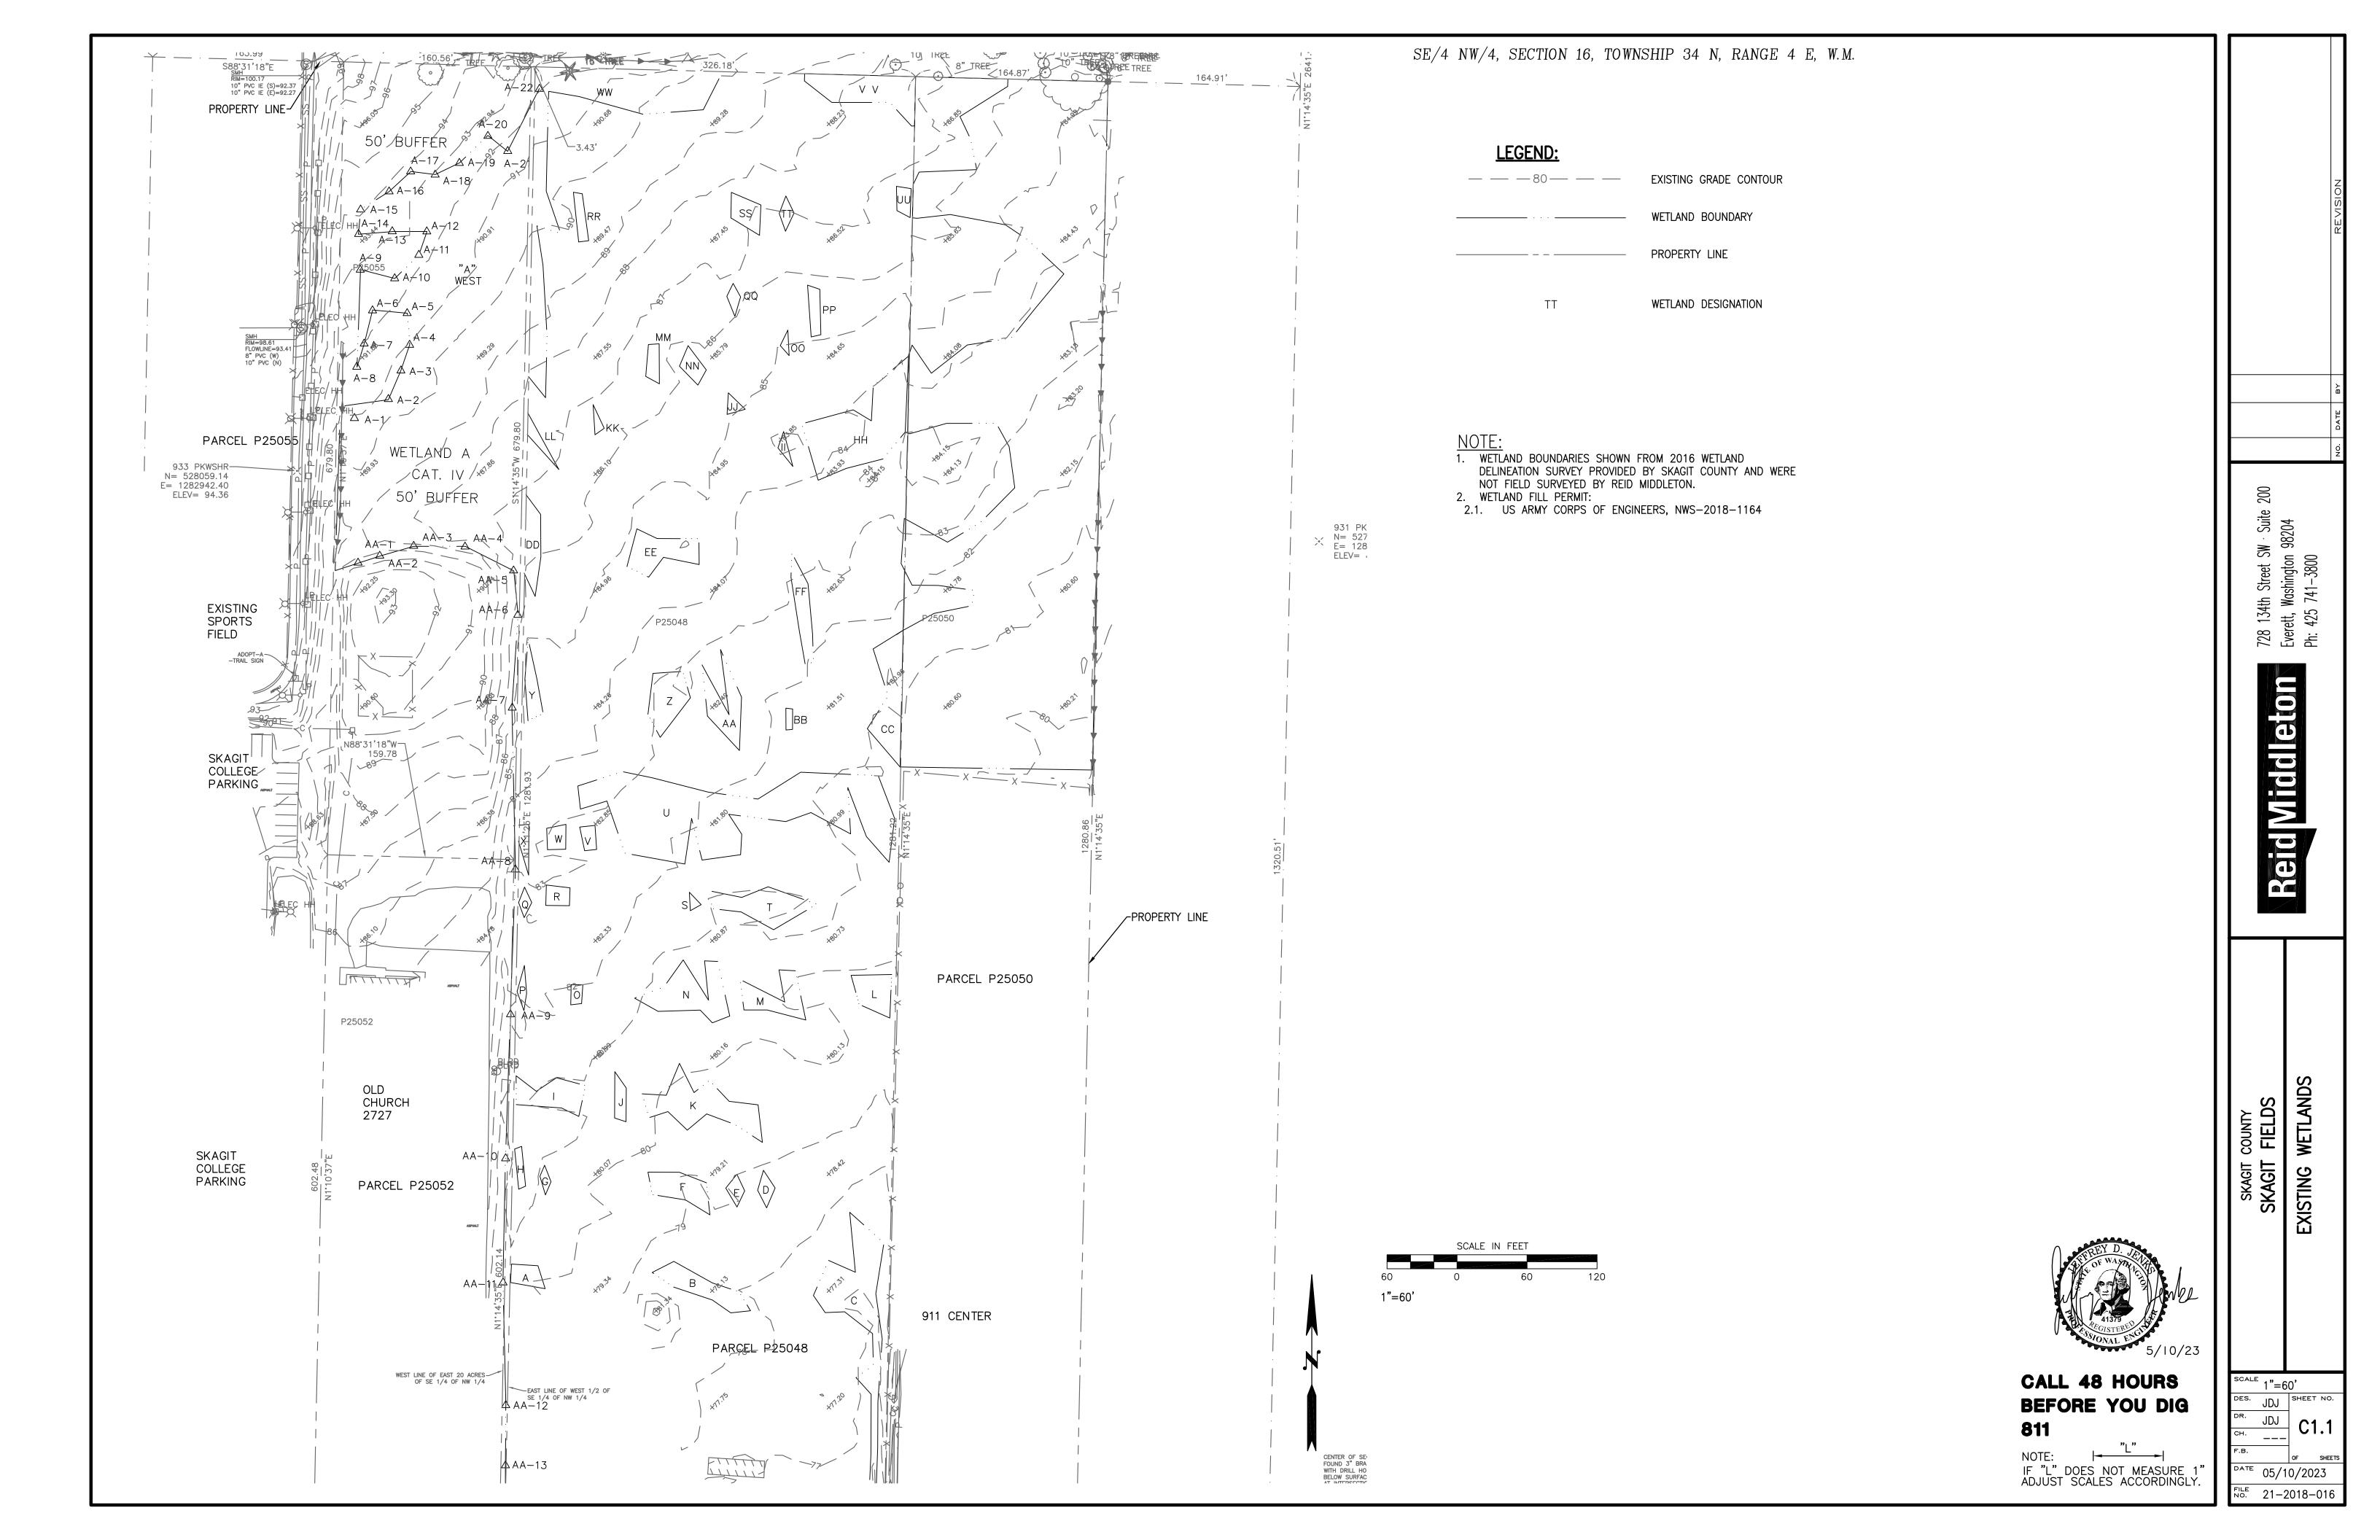

SCALE IN FEET

1"=60'

P25052

DEMOLITION AND CLEARING AND GRUBBING NOTES:

COMPLY WITH CITY OF MOUNT VERNON DEMOLITION PERMIT CONDITIONS.

REMOVE AND DISPOSE DEBRIS TO A SKAGIT COUNTY APPROVED, CONTRACTOR PROVIDED OFFSITE WASTE SITE.

COMPLY WITH WSDOT STANDARD SPECIFICATION SECTION 2-01.3.

MATCHLINE A SEE SHEET C1.3

AND RUNOFF. DO NOT FLUSH SEDIMENT OR CONCRETE BY-PRODUCTS OR CLEAN TRUCKS NEAR OR INTO THE STORM DRAINAGE OR SEWER SYSTEM.

THE IMPLEMENTATION OF THESE ESC PLANS AND THE CONSTRUCTION, MAINTENANCE, REPLACEMENT AND UPGRADING OF THESE FACILITIES IS THE RESPONSIBILITY OF THE OWNER/APPLICANT/SUPERVISOR UNTIL ALL CONSTRUCTION IS APPROVED.

11. ANY AREA OF EXPOSED SOILS, INCLUDING ROADWAY EMBANKMENTS, THAT WILL NOT BE DISTURBED FOR TWO DAYS DURING THE WET SEASON OR SEVEN DAYS DURING THE DRY SEASON SHALL BE IMMEDIATELY STABILIZED WITH THE APPROVED ESC METHODS.


ANY AREA NEEDING ESC MEASURES NOT REQUIRING IMMEDIATE ATTENTION SHALL BE ADDRESSED WITHIN FIFTEEN (15) CALENDAR DAYS. 13. THE ESC FACILITIES ON ACTIVE SITES SHALL BE INSPECTED AND MAINTAINED A MINIMUM OF ONCE A WEEK

AND WITHIN TWENTY-FOUR (24) HOURS FOLLOWING A STORM EVENT. 14. AT NO TIME SHALL MORE THAN ONE (1) FOOT OF SEDIMENT BE ALLOWED TO ACCUMULATE WITHIN A CATCH BASIN. ALL CATCH BASINS AND CONVEYANCE LINES SHALL BE CLEANED PRIOR TO PAVING. THE

CLEANING OPERATION SHALL NOT FLUSH SEDIMENT-LADEN WATER INTO THE DOWNSTREAM SYSTEM. 15. STABILIZED CONSTRUCTION ENTRANCES AND ROADS SHALL BE INSTALLED AT THE BEGINNING OF CONSTRUCTION AND MAINTAINED FOR THE DURATION OF THE PROJECT. ADDITIONAL MEASURES, SUCH AS WASH PADS, MAY BE REQUIRED TO ENSURE THAT ALL OFF-SITE PAVED AREAS ARE KEPT CLEAN FOR THE

DURATION OF THE PROJECT. 16. PRIOR TO THE BEGINNING OF THE WET SEASON THE CONTRACTOR SHALL DETERMINE BMP MEASURES. ALL DISTURBED AREAS SHALL BE INSPECTED BY THE CONTRACTOR TO IDENTIFY WHICH AREAS SHALL BE STABILIZED IN PREPARATION FOR THE WINTER RAINS. DISTURBED AREAS SHALL BE STABILIZED WITHIN ONE

WEEK OF THE BEGINNING OF THE WET SEASON.

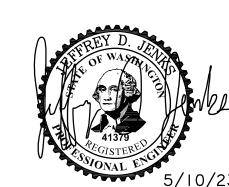


### CALL 48 HOURS **BEFORE YOU DIG** 811

IF "L" DOES NOT MEASURE 1' ADJUST SCALES ACCORDINGLY.

1"=60' DES. JDJ SHEET NO \_\_\_\_\_ C1.2 ---<sup>ATE</sup> 05/10/2023 FILE NO. 21-2018-016

DEMOLITION, C AND

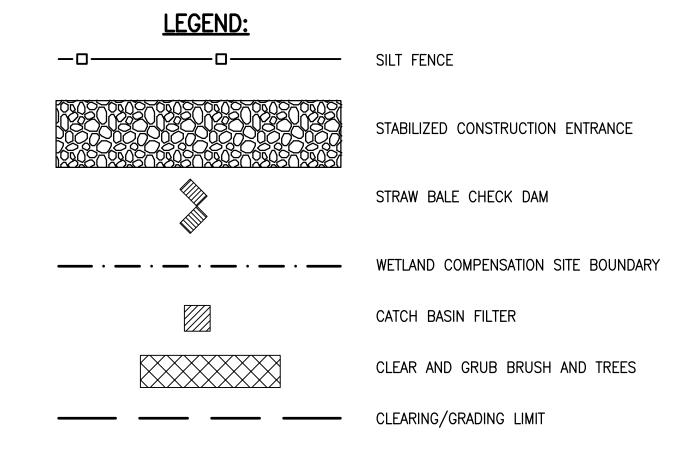

#### **DEMOLITION CONSTRUCTION NOTES:**

- (A) DEMOLISH TREE
- B DEMOLISH BARN
- (C) DEMOLISH GREENHOUSE

### EROSION CONTROL CONSTRUCTION NOTES:

1"=60'


- 1. COMPLY WITH WASHINGTON STATE DEPARTMENT OF ECOLOGY NPDES CONSTRUCTION STORMWATER GENERAL PERMIT.
- 1.1. PRIOR TO BEGINNING WORK, FILE "TRANSFER OF COVERAGE" FORM WITH DEPARTMENT OF ECOLOGY TO TRANSFER PERMITTEE OF NPDES GENERAL PERMIT FROM SKAGIT COUNTY PARKS TO THE CONTRACTOR.
- 1.2. COMPLY WITH ALL PERMIT REQUIREMENTS, PROCEDURES AND REPORTING REQUIREMENTS.
- 1.3. UPDATE AND MAINTAIN STORMWATER POLLUTION PREVENTION PLAN (SWPPP) DOCUMENTS AS REQUIRED BY THE PERMIT.
- 1.4. AT THE COMPLETION OF THE PROJECT, FILE "NOTICE OF TERMINATION" FORM TO DEPARTMENT OF ECOLOGY.
- 1.5. SUBMIT THE FOLLOWING DOCUMENTATION TO SKAGIT COUNTY PARKS:
  1.5.1. COPY OF NOTICE OF TRANSFER AND NOTICE OF TERMINATION FORMS.
- 1.5.2. COPIES OF MONTHLY REPORTS AND TEST RESULTS FILED WITH DEPARTMENT OF ECOLOGY.
- 2. MAINTAIN EROSION CONTROL THROUGH THE DURATION OF THE PROJECT. ADJUST OR MOVE SWALES, BERMS, BALES, SILT FENCES, ETC AS NECESSARY DURING CONSTRUCTION TO DIRECT SITE RUNOFF TO THE SEDIMENT TRAP.
- 3. PROVIDE ADDITIONAL SILT CONTROL AND TEMPORARY EROSION CONTROL MEASURES REQUIRED TO PROTECT SOILS AND PREVENT SILT—LADEN RUNOFF FROM LEAVING PROJECT SITE.
- MONITOR AND MAINTAIN SILT CONTROL MEASURES. INSPECT AND REPAIR TEMPORARY EROSION CONTROL FACILITIES AT LEAST ONCE PER WEEK, DURING AND AFTER STORMS, AND PRIOR TO WEEKENDS AND HOLIDAYS.

#### DEMOLITION AND CLEARING AND GRUBBING NOTES:

- 1. COMPLY WITH WSDOT STANDARD SPECIFICATION SECTION 2-01.3.
- 2. REMOVE AND DISPOSE DEBRIS TO A SKAGIT COUNTY APPROVED, CONTRACTOR PROVIDED OFFSITE WASTE SITE.
- 3. COMPLY WITH CITY OF MOUNT VERNON DEMOLITION PERMIT CONDITIONS.

#### EROSION CONTROL MATERIAL NOTES:

- . FILTER FABRIC FENCE:
- 1.1. WSDOT STANDARD PLAN I-30.15-02.
- 2. WSDOT STANDARD SPECIFICATIONS SECTION 9-33, TABLE 6, GEOTEXTILE FOR TEMPORARY SILT FENCE
- FILTER BAG INSERTS:
- 2.1. WSDOT STANDARD PLAN I-40.20-00.
- ..2. COMMERCIALLY MANUFACTURED FILTER BAGS SPECIFICALLY MANUFACTURED FOR SILT FILTERING AND WHICH WILL PROVIDE FILTERING PERFORMANCE REQUIRED.
- QUARRY SPALLS: WSDOT STANDARD SPECIFICATION SECTION 9-13.6

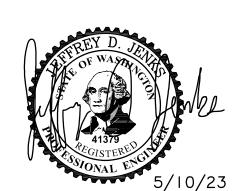

CALL 48 HOURS
BEFORE YOU DIG
811

NOTE: |- L |- |

IF "L" DOES NOT MEASURE 1"

ADJUST SCALES ACCORDINGLY.

Suite 200
8204
No. Date BY

Fig. WICOLDION Everett, Washington 982 Ph: 425 741–3800

EROSION

ARING AND TEMPORAR DIMENT CONTROL PLA

DEMOLITION, CLEARING AND SEDIMENT

SCALE 1"=60'

DES. JDJ SHEET NO.


DR. JDJ C1.3

CH. \_\_\_\_

F.B. OF SHEE


DATE 05/10/2023

FILE 21-2018-016

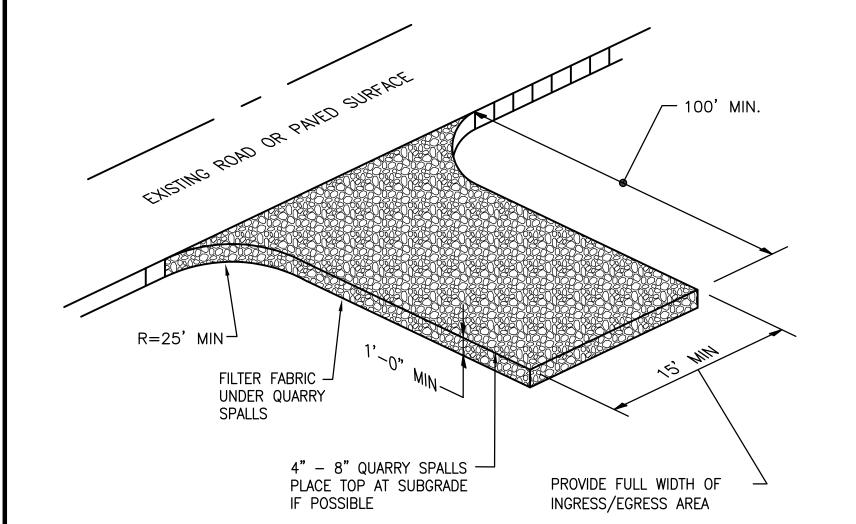

1 STABILIZED CONSTRUCTION ENTRANCE
C1.2 C1.3 NOT TO SCALE

NOTES: 728 134th Street SW · Suite 20

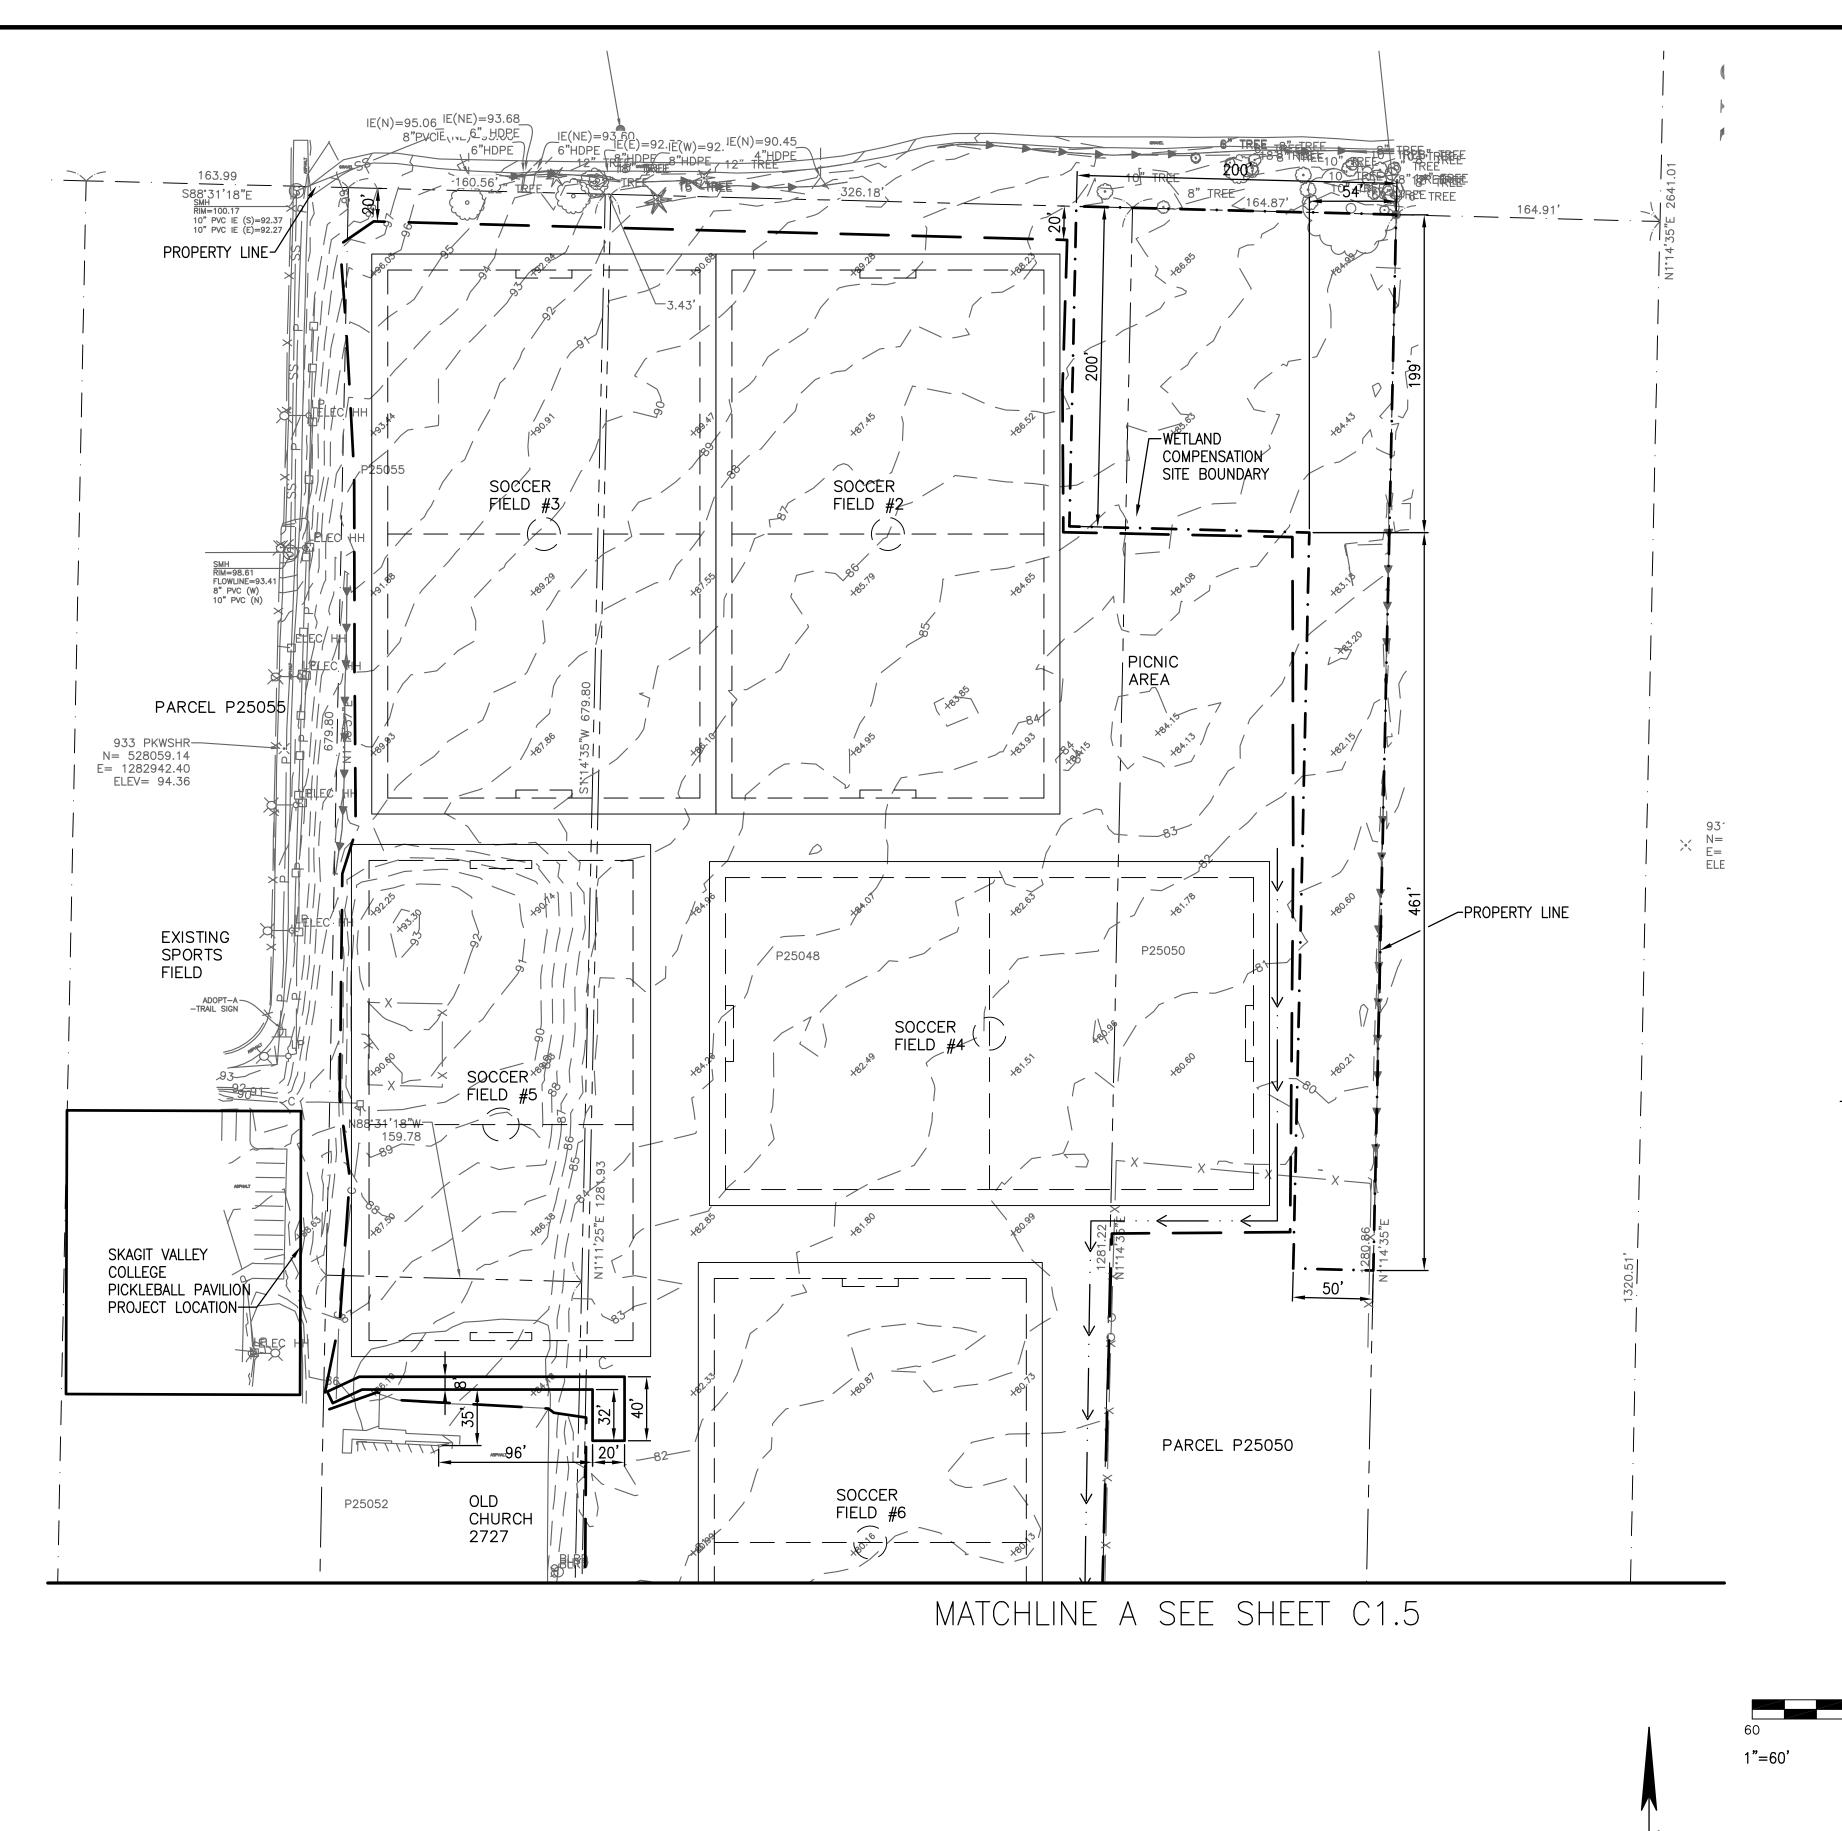

SE/4 NW/4, SECTION 16, TOWNSHIP 34 N, RANGE 4 E, W.M.

# 

WETLAND COMPENSATION SITE BOUNDARY


ф [ ] ф [

NON-PERMANENT SOCCER FIELD LAYOUT (SHOWN FOR INFORMATION ONLY)

WOOD CHIP PATH, 8' WIDE, TYPICAL

#### LAYOUT NOTES:

1. SOCCER FIELD LAYOUT IS SHOWN FOR INFORMATION ONLY. NO PERMANENT FIELD MARKINGS OR BOUNDARIES WILL BE CONSTRUCTED.

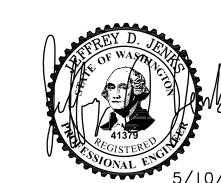


CALL 48 HOURS
BEFORE YOU DIG
811


NOTE: | - "L" - |

IF "L" DOES NOT MEASURE 1"

ADJUST SCALES ACCORDINGLY.

FILE 21-2018-016

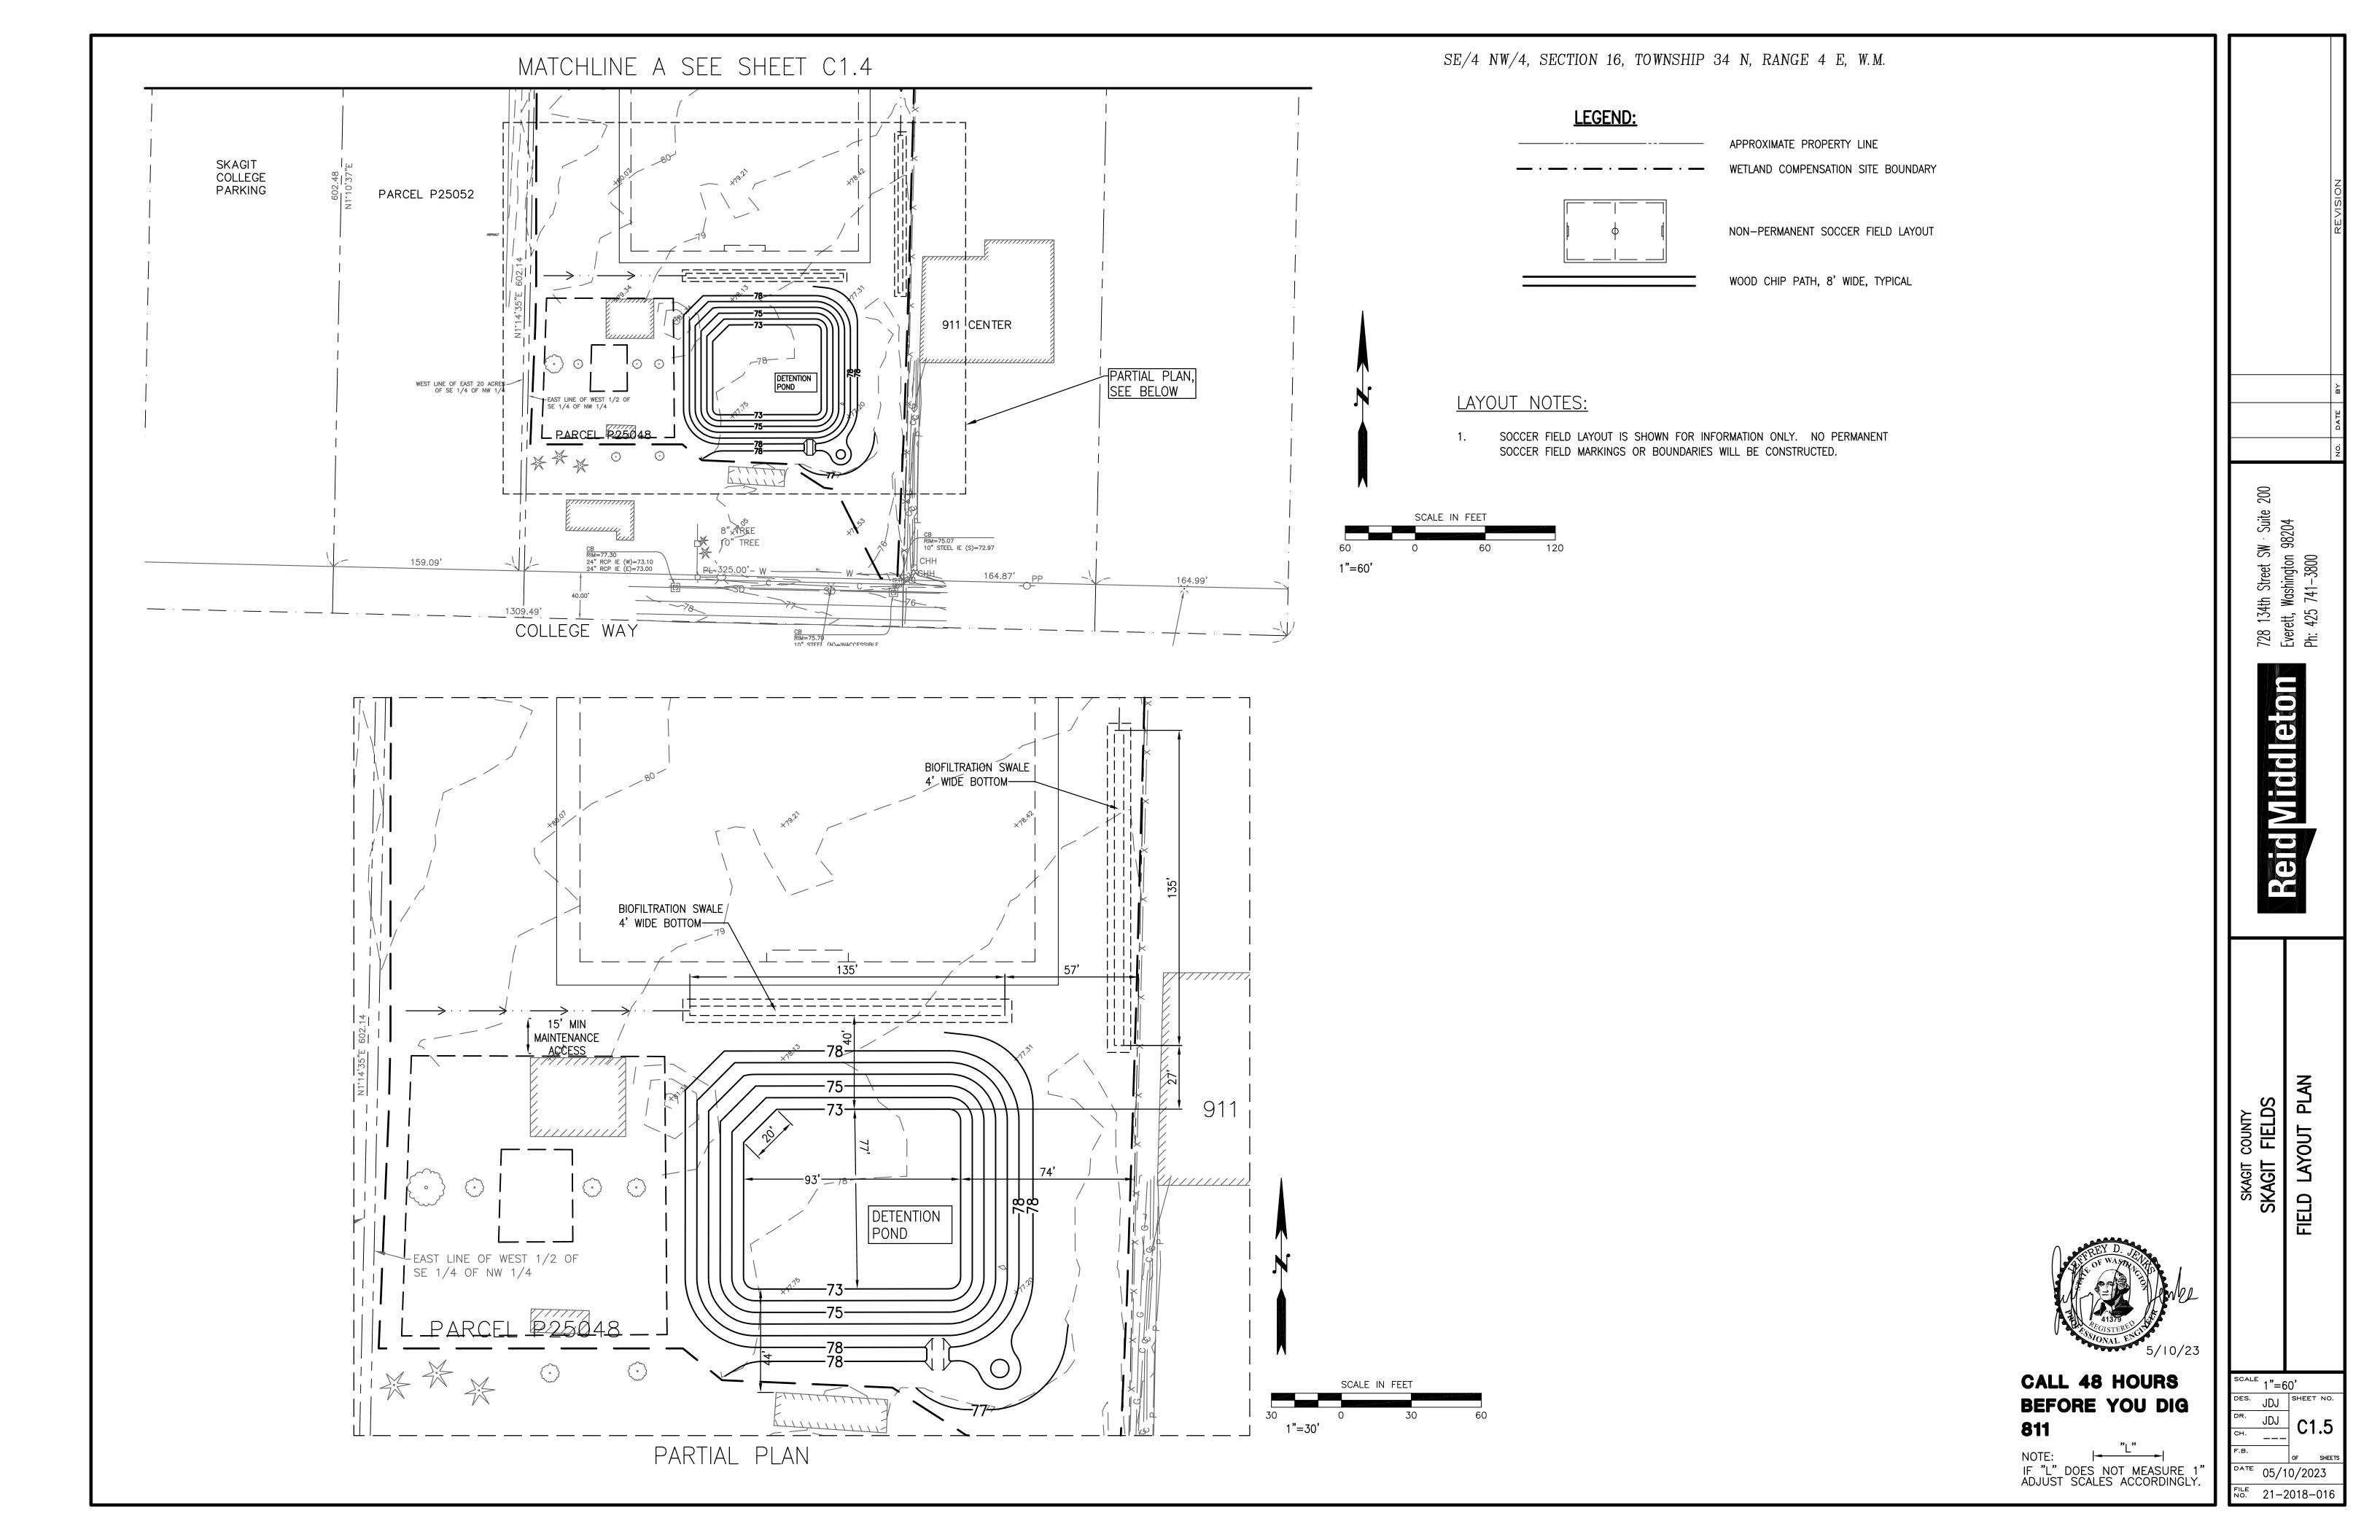

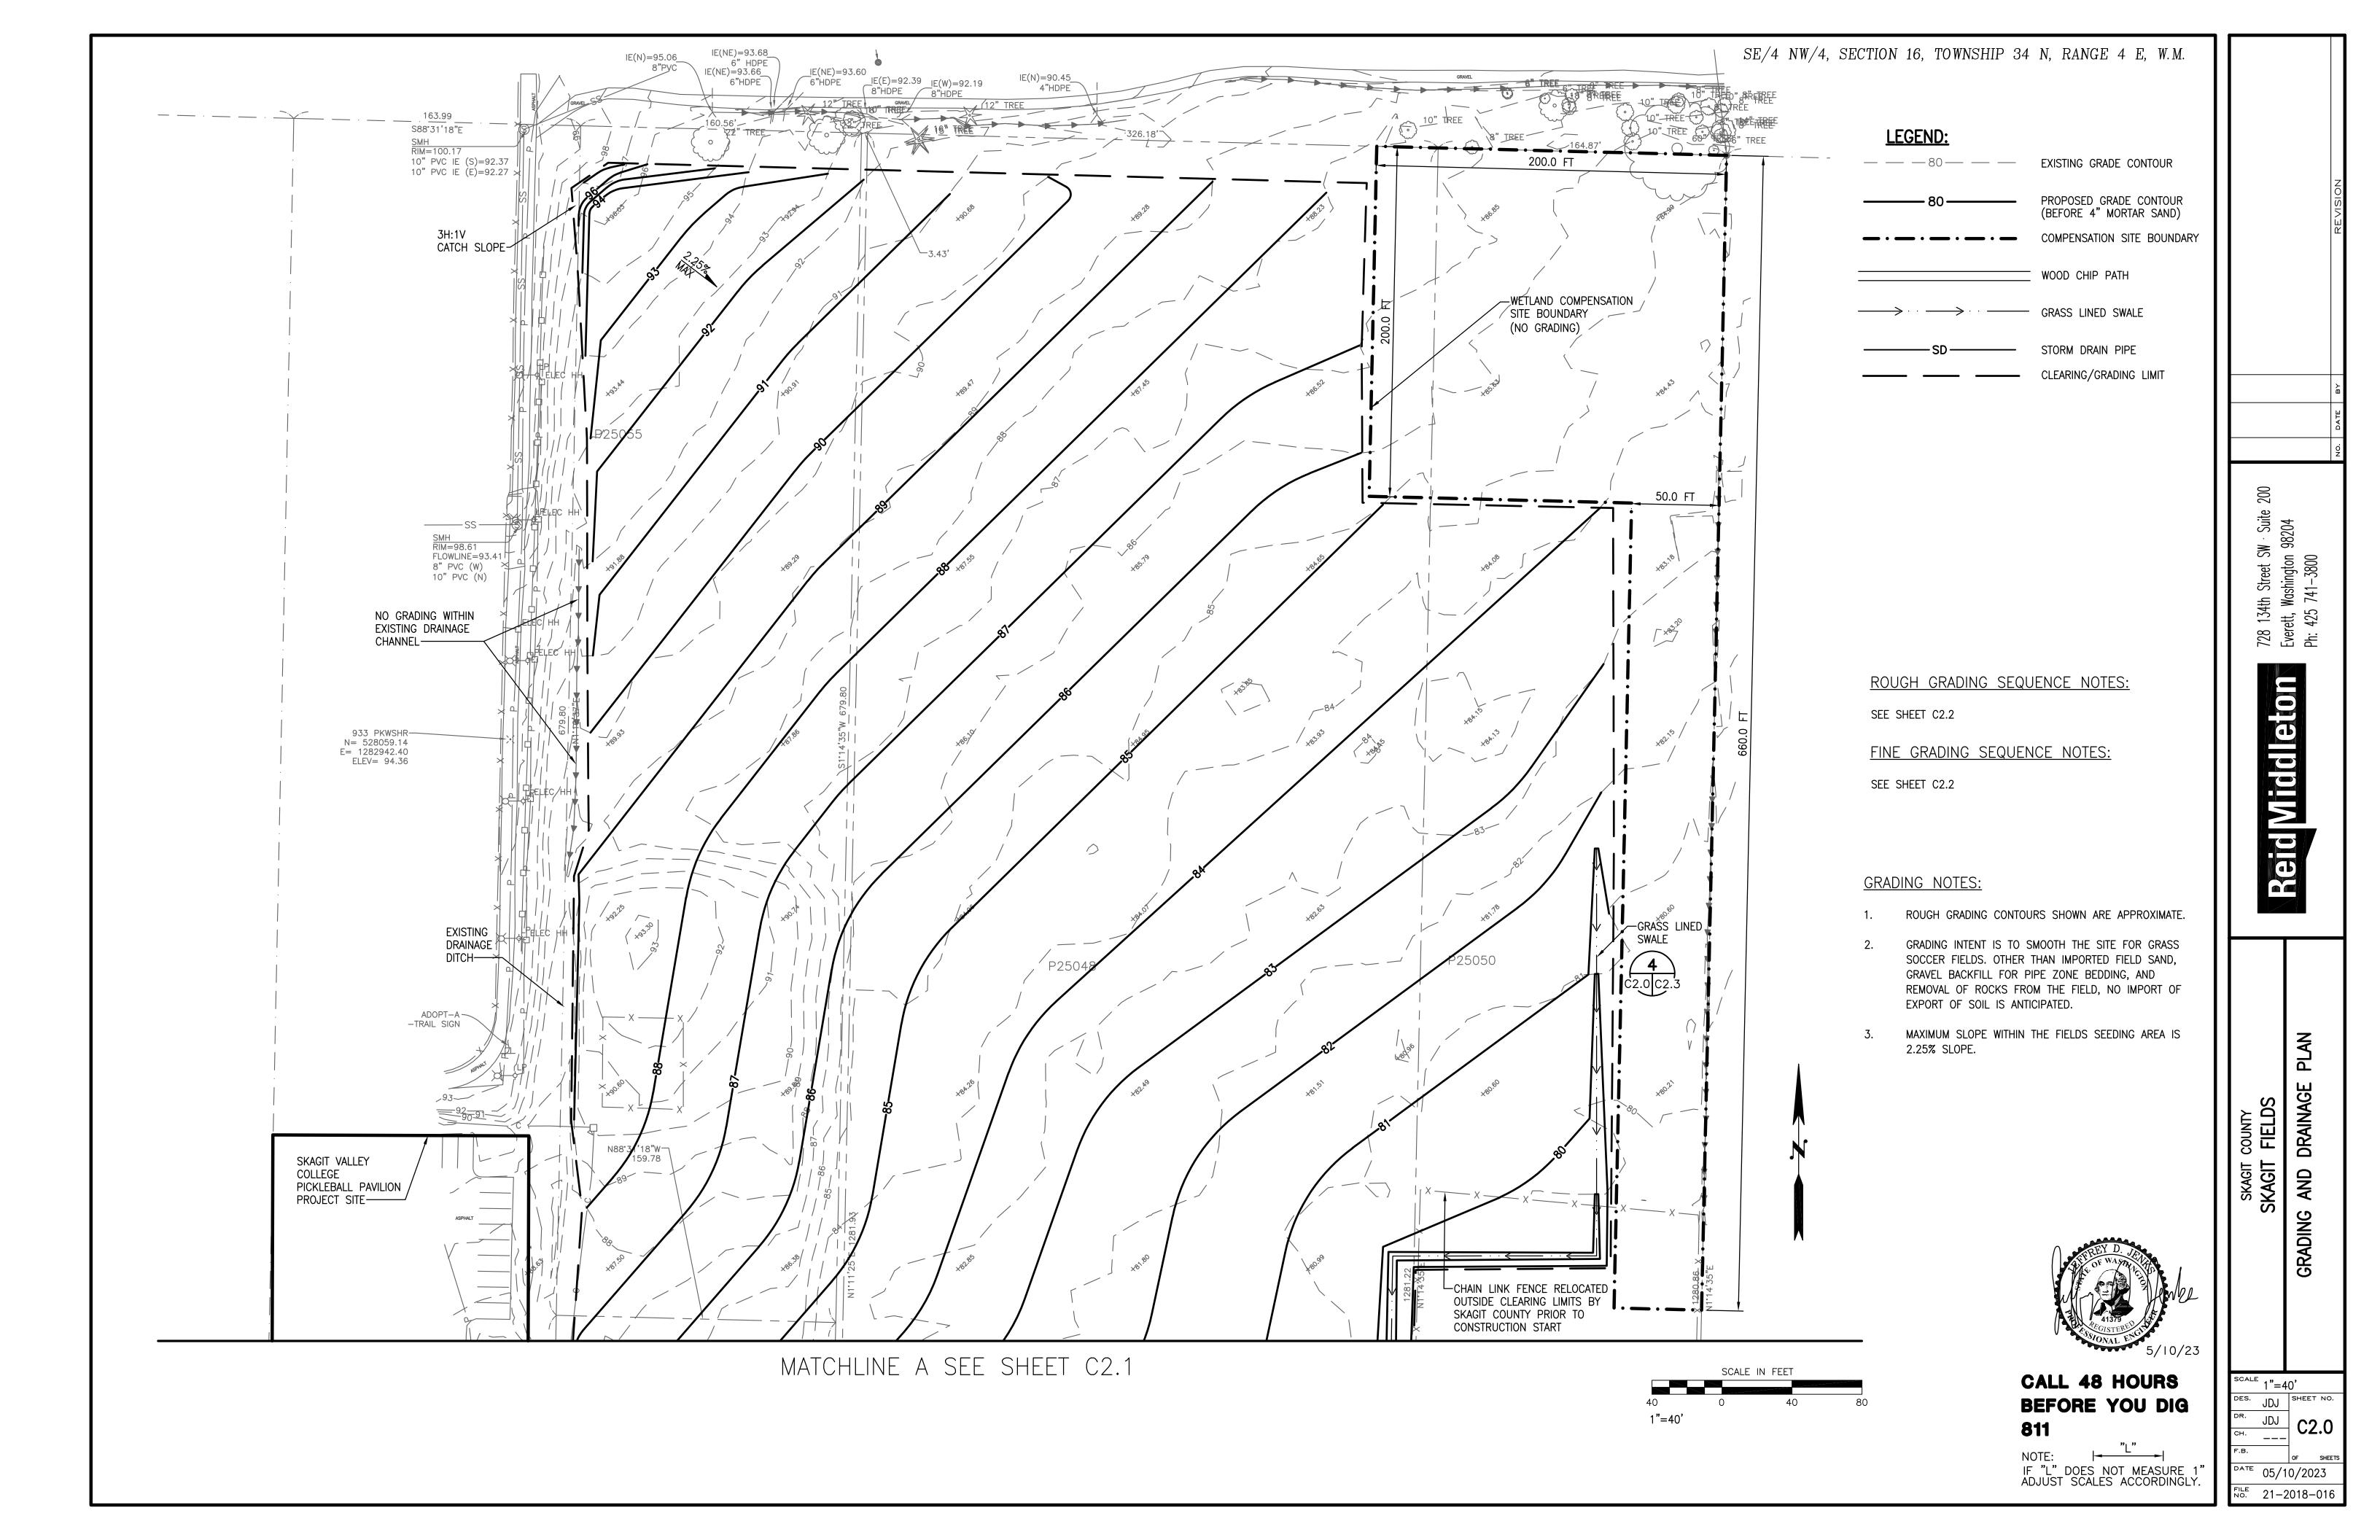

00.

728 134th Street SW·Suite 2 Everett, Washington 98204 Ph: 425 741—3800

AND DRAINAGE PLAN

**6R/** 

DES. JDJ SHEET NO.

DR. JDJ CH. --
F.B. OF SHEET

DATE 05/10/2023 File 21-2018-016

- 2. THE CONTRACTOR SHALL CALL FOR REQUIRED INSPECTIONS BY CALLING THE INSPECTION LINE NUMBER (360)336-6243. FAILURE TO PROPERLY NOTIFY THE CITY OF REQUIRED INSPECTION MIGHT RESULT ON NON-ACCEPTANCE OF THE WORK.
- 3. ALL CONTRACTORS WORKING IN THE CITY OF MOUNT VERNON MUST HAVE A CITY OF MOUNT VERNON BUSINESS LICENSE.
- 4. IT IS THE GENERAL CONTRACTOR'S RESPONSIBILITY TO LOCATE ALL UTILITIES PRIOR TO THE START OF CONSTRUCTION. CONTACT "ONE CALL": 1-800 424-5555 (OR 811)
- 5. ALL CONTRACTORS, SUBCONTRACTORS, TRADES AND CRAFTS PERFORMING WORK DURING CONSTRUCTION MUST ADHERE TO THE SAFETY REGULATIONS FOR CONTRACTORS AND OWNER'S EMPLOYEES IN ACCORDANCE WITH CURRENT WISHA STANDARDS AND REQUIREMENTS.
- 6. IN ADDITION TO MEETING THE CURRENT CITY OF MOUNT VERNON ENGINEERING STANDARD, ALL CONSTRUCTION SHALL BE IN CONFORMANCE WITH THE WASHINGTON STATE DEPARTMENT OF TRANSPORTATION STANDARD SPECIFICATIONS AND THE AMERICAN PUBLIC WORKS ASSOCIATION STANDARDS AND PRACTICES.
- 7. NATIVE FILL AND/OR MATERIAL WILL NOT BE ALLOWED IN UTILITY TRENCHES AND INSIDE THE ROAD PRISM. PLEASE BE AWARE THAT CITY CODES, STANDARDS AND DETAILS SUPERSEDE.
- 8. TRAFFIC CONTROL SHALL STRICTLY ADHERE TO THE MANUAL OF UNIFORM TRAFFIC CONTROL DEVICES (MUTCD) STANDARDS. BEFORE ISSUANCE OF A RIGHT-OF WAY PERMIT, THERE IS TO BE AN APPROVED TRAFFIC CONTROL PLAN BY THE CITY'S DEVELOPMENT SERVICES ENGINEERING DIVISION. NO FULL ROAD CLOSURES WILL BE ALLOWED UNLESS APPROVED BY THE PUBLIC WORKS DIRECTOR.
- 9. 72 HOUR NOTICE IS REQUIRED FOR LANE CLOSURE NOTIFICATIONS
- 10. SURVEY STAKING IS REQUIRED FOR ALL UTILITIES AND LOT CORNERS.
- 11. SCHEDULE INSPECTIONS 24 HOURS IN ADVANCE. INSPECTION REQUESTS MUST BE CALLED IN BEFORE 8 AM FOR SAME DAY INSPECTIONS. THE INSPECTION LINE NUMBER IS (360)336-6243.
- 12. THE PERMITEE IS RESPONSIBLE FOR DAMAGES TO CITY PROPERTY, PAVEMENT, WALKS, UTILITIES, STREET STRIPING, THERMOPLASTICS OR UNDERGROUND CABLES. TRAFFIC SIGNAL DETECTION LOOPS DAMAGED BY CONSTRUCTION WILL BE REPLACED AT THE CONTRACTOR'S EXPENSE UNLESS DIRECTED OTHERWISE BY THE PUBLIC WORKS DIRECTOR.
- 13. COATED 12 GAUGE OR 14 GAUGE LOCATION WIRE MUST BE INSTALLED OVER ALL UNDERGROUND PVC OR OTHER NON-METALLIC PIPE UNLESS DIRECTED OTHERWISE BY THE INSPECTOR.
- 14. REVISIONS TO THE APPROVED CIVIL PLANS MUST BE SUBMITTED FOR REVIEW AND APPROVAL BY THE DEVELOPMENT SERVICES ENGINEERING MANAGER.
- 15. CONSTRUCTION AS—BUILT REQUIREMENTS ARE AS FOLLOWS: THE SITE SHALL BE RESURVEYED AND PLANS APPROPRIATELY MODIFIED BY THE ENGINEER OF RECORD. SUBMIT 1 RED LINED COPY OF PLANS TO APPROVE FOR AS—BUILT.
- 16. AFTER APPROVAL AND RETURN OF RED LINE PLANS, NEED 1 HARD COPY PLUS 1 AUTOCAD, 1 PDF AND 1 TIF FILE OF FINAL AS—BUILT ON CD, PRIOR TO THE ISSUANCE OF THE CERTIFICATE OF OCCUPANCY OR FINAL INSPECTION.
- 17. ALL GRADING DESIGN AND CONSTRUCTION ACTIVITY SHALL COMPLY TITLE 15.16, ALL MOUNT VERNON MUNICIPAL CODE, INCLUDING BUT NOT LIMITED TO 13.33 STORMWATER DRAINAGE UTILITY AND 15.40 CRITICAL AREAS.
- 18. ALL GRADING DESIGN AND CONSTRUCTION ACTIVITY SHALL COMPLY WITH THE CITY OF MOUNT VERNON ENGINEERING STANDARDS AND THE CURRENT WSDOT STANDARD SPECIFICATIONS FOR ROAD, BRIDGE AND MUNICIPAL CONSTRUCTION.
- 19. A PRE-CONSTRUCTION MEETING IS REQUIRED PRIOR TO ANY CONSTRUCTION OR GRADING ACTIVITY.
- 20. A COPY OF THE FILL & GRADE PERMIT AND APPROVED PLANS SHALL BE KEPT ON-SITE DURING CONSTRUCTION.
- 21. DEVIATION AND REVISIONS TO THE APPROVED PLANS SHALL BE APPROVED BY THE PROJECT'S ENGINEER AND THE CITY OF MOUNT VERNON.
- 22. RETAINING WALL GREATER THAN 4-FEET IN HEIGHT REQUIRE SEPARATE BUILDING PERMIT.
- 23. NO GRADING ACTIVITY MAY OCCUR WITHIN A CRITICAL AREA OR CRITICAL AREA BUFFER WITHOUT SPECIFIC APPROVAL.
- 24. IT SHALL BE THE RESPONSIBILITY OF BOTH THE PERMITTEE AND THE PROPERTY OWNER TO ADVISE THE CITY IMMEDIATELY OF ANY DISCREPANCIES, HAZARDOUS CONDITIONS OR PROBLEMS AFFECTING SAFETY AND STABILITY OF THE PROJECT
- 25. UNLESS OTHERWISE RECOMMENDED IN THE GEOTECHNICAL REPORT: THE SLOPE OF CUT SURFACES SHALL BE NO STEEPER THAN IS SAFE FOR THE INTENDED USE, AND SHALL NOT BE STEEPER THAN THREE UNITS HORIZONTAL TO ONE UNIT VERTICAL (3:1).
- 26. ALL FILL MATERIAL SHALL MEET THE STANDARD FOR THE INTENDED FUTURE USE. MATERIAL TO BE PLACE IN AREAS OF FUTURE BUILDING SITE SHALL BE STRUCTURAL FILL MATERIAL. TESTING SHALL BE REQUIRED AS DEEMED NECESSARY BY THE CITY OF MOUNT VERNON.
   27. THE GROUND SURFACE SHALL BE PREPARED TO RECEIVE FILL BY REMOVING VEGETATION,
- TOPSOIL AND OTHER UNSUITABLE MATERIALS, AND SCARIFYING THE GROUND TO PROVE A BOND WITH THE FILL MATERIAL.

  28. FILL MATERIAL SHALL NOT INCLUDE ORGANIC, FROZEN OR OTHER DELETERIOUS MATERIALS. NO

ROCK OR SIMILAR IRREDUCIBLE MATERIAL GREATER THAN 12-INCHES IN ANY DIMENSION SHALL

- BE INCLUDED IN FILLS.

  29. ALL FILL MATERIAL SHALL BE COMPACTED AT A MINIMUM TO 90 PERCENT OF MAXIMUM DENSITY AS DETERMINED BY ASTMD 1557 MODIFIED PROCTOR, IN LIFTS NOT EXCEEDING 12—INCHES IN DEPTH. TESTS TO DETERMINE THE DENSITY OF COMPACTED FILLS SHALL BE MADE ON THE BASIS OF NOT LESS THAN ONE TEST PER 7000 SQUARE FEET OF COMPACTED AREA PER 2—FOOT VERTICAL LIFT. ADDITIONAL TESTING MAY BE REQUIRED AT THE DIRECTION
- OF THE CITY INSPECTOR.

  30. COMPACTION OF TEMPORARY STOCKPILE FILLS SHALL NOT BE REQUIRED, EXCEPT WHERE THE BUILDING OFFICIAL DETERMINES THAT COMPACTION IS NECESSARY AS A SAFETY MEASURE.
- 31. PROPERTY LOCATION AND APPROVED SETBACKS MUST BE ESTABLISHED AND STAKES SET UNDER THE SUPERVISION OF A REGISTERED LAND SURVEYOR WHEN GRADING ACTIVITIES OCCUR. THOSE STAKES MUST BE MAINTAINED IN PLACE UNTIL FINAL INSPECTION OF WORKS SO THAT THE INSPECTOR CAN DETERMINE AT ANY TIME IF THE EXCAVATION IS PROPERLY LOCATED AS RELATED TO PROPERTY LINES.
- 32. SETBACK DIMENSIONS SHALL BE MEASURED PERPENDICULAR TO THE PROPERTY LINE.
- 33. THE SETBACK AT THE TOP OF A CUT SLOPE SHALL NOT BE LESS THAN 5-FEET OR THAN IS REQUIRED TO ACCOMMODATE ANY REQUIRED INTERCEPTOR DRAINS, WHICHEVER IS GREATER.
- 34. THE TOE OF A SLOPE DISTANCE TO PROPERTY AND EASEMENT LINES SHALL BE AS FOLLOWS: FOR SLOPES LESS THAN 11-FEET IN HEIGHT THE MINIMUM DISTANCE SHALL BE 5-FEET. FOR SLOPES 11-FEET IN HEIGHT OR GREATER THE MINIMUM DISTANCE SHALL BE HEIGHT/2

- 35. THE TOP OR TOE OF A SLOPE DISTANCE TO A STRUCTURE SHALL BE NOT LESS THAN 10 FEET.
- 36. DRAINAGE SHALL BE PROVIDED IN ACCORDANCE WITH CITY OF MOUNT VERNON MUNICIPAL CODE 13.33 AND ENGINEERING STANDARDS AS THEY ARE CURRENTLY WRITTEN OR AS THEY MAY BE AMENDED IN THE FUTURE.
- 37. TERRACING AND BENCHING SHALL BE PROVIDED AS RECOMMENDED IN THE GEOTECHNICAL REPORT
- 38. INTERCEPTOR DRAINS SHALL BE INSTALLED ALONG THE TOP OF CUT SLOPES RECEIVING DRAINAGE FROM A TRIBUTARY WIDTH GREATER THAN 40-FEET, MEASURE HORIZONTALLY. DRAINS SHALL BE CONSTRUCTED OF SOLID, NOT FLEXIBLE, PIPE.
- 39. DOWN DRAINS SHALL TERMINATE INTO A CATCH BASIN OR OTHER APPROVED RECEIVER TO PREVENT SCOURING AT THE OUTFALL.
- 40. FOR CONSTRUCTION SITE 1—ACRE OR LARGER A CERTIFIED EROSION & SEDIMENT CONTROL LEAD SHALL BE IDENTIFIED FOR THE PROJECT AND SHALL BE ON—CALL AT ALL TIMES. THE NAME AND PHONE NUMBER OF THE CONTACT PERSON SHALL BE POSTED ON SITE.
- 41. NO TRACKING OF MUD OR DEBRIS ON TO PUBLIC STREETS IS ALLOWED.
- 42. ALL GRADING ACTIVITY IS LIMITED TO THE HOURS BETWEEN 7:00 AM AND 9:00 PM MONDAY THROUGH FRIDAY AND 8:00 AM AND 9:00 PM SATURDAY AND SUNDAY. THE BUILDING OFFICIAL IS AUTHORIZED TO GRANT AN EXTENSION OF WORKING HOURS.
- 43. PROJECTS SHALL BE INSPECTED AT VARIOUS STAGES OF THE WORK TO DETERMINE THAT ADEQUATE CONTROL IS BEING EXERCISED. STAGES OF WORK SUBJECT TO INSPECTION INCLUDE, BUT ARE NOT LIMITED TO: PRE—CONSTRUCTION, EROSION CONTROL, GRADING ACTIVITIES, INSTALLATION OF UTILITIES, STORMWATER FACILITIES, RETAINING WALLS, LANDSCAPING AND COMPLETION OF PROJECT.

#### CITY OF MOUNT VERNON STORM DRAIN NOTES:

- 1. ALL PIPE MATERIAL, JOINTS AND PROTECTIVE TREATMENT SHALL BE IN ACCORDANCE WITH WSDOT SPECIFICATIONS UNLESS OTHERWISE SPECIFIED.
- 2. ON SITE-CONVEYANCE PIPE SHALL BE RIGID GASKETED PIPES
- 3. STORM PIPE SHALL BE A MINIMUM OF 12 INCHES DIAMETER UNLESS OTHERWISE SPECIFIED
- 4. WYES OR TEES WILL BE ALLOWED ON ROOF/YARD DRAIN SYSTEMS WITH CLEAN-OUTS UPSTREAM. CLEAN-OUTS MUST BE LOCATED OUTSIDE CITY ROW
- 5. ALL CONNECTIONS TO STORM STRUCTURES MUST HAVE SAND COLLARS IF SMOOTH OUTSIDE WALL PVC AND MUST BE INSPECTED PRIOR TO BACKFILLING. CONNECTIONS TO THE STORM WATER SYSTEM SHALL BE MADE ONLY AT STRUCTURES UNLESS OTHERWISE APPROVED.
- 6. STORM SEWER STUB TO BE IDENTIFIED WITH A PAINTED WHITE PRESSURE TREATED 2" X 4" MARKER BOARD INDICATING THE DEPTH TO THE TOP OF THE PIPE WITH A CLEAN OUT AT THE PROPERTY LINE.
- 7. PIPE COVER SHALL BE 24" MINIMUM UNLESS OTHERWISE SPECIFIED.
- 8. RESTRICTOR ORIFICE/ FLOW CONTROL ASSEMBLY MUST BE INSPECTED PRIOR TO INSTALLATION.
- 9. NEW STORM SEWER SYSTEMS AND RECONNECTION TO EXISTING SYSTEMS MUST BE VACTORED, SCREENED AND FLUSHED PRIOR TO FINAL ACCEPTANCE.
- 10. DETENTION PONDS DESIGNED FOR USE AS SEDIMENT PONDS SHALL BE CLEANED OF SEDIMENT ACCUMULATION BEFORE CONNECTION TO CITY STORMWATER SYSTEM AND BEFORE ACCEPTANCE OF THE PROJECT
- 11. PVC PIPE SHALL BE ENCASED IN A STEEL OR DUCTILE IRON CASING WHEN CROSSING UNDER IMPROVEMENTS WHERE THE ABILITY TO REMOVE AND REPLACE PIPE WITHOUT DISTURBANCE TO THE IMPROVEMENT IS NEEDED
- 12. CASINGS SHALL EXTEND A MINIMUM OF 5' PAST EACH EDGE OF THE IMPROVEMENT, OR A DISTANCE EQUAL TO THE DEPTH OF PIPE, WHICHEVER IS GREATER. THE CARRIER PIPE SHALL BE SUPPORTED BY CASING SPACERS WHERE CASING LENGTH EXCEEDS 10'

#### GENERAL NOTES:

- 1. SITE DESIGN IS BASED ON SURVEY PREPARED BY REID MIDDLETON.
- 2. CONTRACTOR SHALL BE RESPONSIBLE FOR LOCATING AND PROTECTING ALL EXISTING UTILITIES TO REMAIN. FIELD VERIFY THE LOCATION OF UTILITIES PRIOR TO BEGINNING CONSTRUCTION. CALL THE UNDERGROUND UTILITY LOCATING SERVICE LOCATE LINE AT "811" ASSISTANCE IN LOCATING UNDERGROUND UTILITIES. THE UNDERGROUND UTILITY LOCATING SERVICE WILL NOT LOCATE ALL UTILITIES.
- TRAFFIC LANES IN PUBLIC STREETS SHALL BE MAINTAINED AND ANY PARTIAL ROAD CLOSURES REQUIRED SHALL BE APPROVED BY THE CITY OF MOUNT VERNON FIRE, POLICE AND ENGINEERING DEPARTMENTS PRIOR TO CONSTRUCTION.
- 4. SEE EROSION CONTROL GENERAL NOTES ON SHEET C1.2 AND C1.3.

#### **GENERAL CONSTRUCTION REQUIREMENTS**

 ALL WORK AND MATERIAL SHALL CONFORM TO THE 2020 WASHINGTON STATE DEPARTMENT OF TRANSPORTATION STANDARD SPECIFICATIONS AND CURRENT WASHINGTON STATE DEPARTMENT OF TRANSPORTATION STANDARD PLANS FOR ROAD, BRIDGE AND MUNICIPAL CONSTRUCTION.

#### ROUGH GRADING SEQUENCE NOTES:

- 1. CLEAR AND GRUB AS SHOWN ON SHEET C1.2 AND C1.3
- TILL EXISTING GRASS 12" DEEP.
- 3. GRADE SITE TO PROPOSED CONTOURS.
- 4. BREAK UP CLODS LARGER THAN 4-INCHES.


## FINE GRADING SEQUENCE NOTES:

AFTER COMPLETION OF ROUGH GRADING:

- 1. APPLY 4" OF SAND TO SURFACE AND CULTIVATE TOPSOIL TO A MINIMUM 6" DEPTH BY SCARIFYING OR OTHER DISKING METHODS TO THOROUGHLY INCORPORATE AMENDMENTS INTO THE TOPSOIL. MAINTAIN A LOOSE FRIABLE SEED BED. AT NO TIME WILL RUBBER TIRED LOADERS OR GRADERS HAVING GREATER COMPACTION THAN A SMALL FARM TRACTOR BE ALLOWED ON TOPSOIL. KEEP ALL HEAVY EQUIPMENT AND TRUCKS OFF PREPARED TOPSOIL. DO NOT PREPARE WHILE GROUND IS WET OR FROZEN.
- 2. APPLY LIME AND AMENDMENT FERTILIZER TO SAND/SOIL. MIX LIME & FERTILIZER INTO TOP 4-6" OF SOIL BY RAKING OR TILLING.
- 3. RE-GRADE WHERE AND AS REQUIRED TO PROPERLY MEET ALL PROPOSED FINISH GRADES.
- 4. REMOVE FROM SURFACE ANY VISIBLE WEEDS, DEBRIS, FOREIGN MATTER AND STONES HAVING ANY DIMENSION GREATER THAN 1". REMOVE FROM PROPERTY.
- 5. FINE GRADE TO A SMOOTH UNIFORM SURFACE. THE ENTIRE AREA SHALL PRESENT AN EVEN GRADE WITH NO DEPRESSIONS WHERE WATER WILL STAND. TOPSOIL SHALL BE SMOOTHLY BLENDED TO EXISTING FINISH GRADES AND ADJACENT EXISTING CONDITIONS, MAINTAIN DESIGNED SURFACE DRAINAGE PATTERNS. ROUND OFF ALL TOP AND TOE OF SLOPES. AREA CAN BE LIGHTLY ROLLED.
- 6. APPROVAL OF SURFACE BY OWNERS REP SHALL BE OBTAINED BEFORE SEEDING OPERATIONS BEGIN.
- 7. HYDROSEEDING: MIX SPECIFIED FIELD SEED, SLOW-RELEASE STARTER FERTILIZER (SECONDARY / IN ADDITION TO AMENDMENT FERTILIZER), AND FIBER MULCH IN WATER, USING EQUIPMENT SPECIFICALLY DESIGNED FOR HYDROSEED APPLICATION. CONTINUE MIXING UNTIL UNIFORMLY BLENDED INTO HOMOGENEOUS SLURRY SUITABLE FOR HYDRAULIC APPLICATION.
- 7.1. MIX SLURRY WITH FIBER-MULCH MANUFACTURER'S RECOMMENDED TACKIFIER.
- 7.2. SPRAY-APPLY SLURRY UNIFORMLY TO ALL AREAS TO BE SEEDED IN A TWO-STEP PROCESS. APPLY FIRST SLURRY COAT AT A RATE SO THAT MULCH COMPONENT IS DEPOSITED AT NOT LESS THAN 500-LB/ACRE DRY WEIGHT, AND SEED COMPONENT IS DEPOSITED AT NOT LESS THAN THE SPECIFIED SEED-SOWING RATE. APPLY SLURRY COVER COAT OF FIBER MULCH (HYDRO MULCHING) AT A RATE OF 1000 LB./ACRE
- 7.3. SEE FIELD MATERIAL NOTES FOR SEED MIX.

#### **ACCEPTANCE:**

1. FIELD SEEDED TURF WILL BE SATISFACTORY AND ELIGIBLE FOR OWNER'S ACCEPTANCE PROVIDED ALL REQUIREMENTS HAVE BEEN MET AND A HEALTHY, UNIFORM, DENSE STAND OF GRASS IS ESTABLISHED, FREE OF WEEDS AND BARE SPOTS AND SURFACE IRREGULARITIES, WITH COVERAGE EXCEEDING 90 PERCENT OVER ANY 5-FOOT SQUARE SELECTED BY THE ENGINEER. ENGINEER OR REP SELECTED BY THE OWNER SHALL BE THE SOLE JUDGE OF ACCEPTANCE. LAWNS MUST BE FREE OF WEEDS, CRABGRASS, AND OTHER UNDESIRABLE PLANTS, WITH NO DISEASES PRESENT. ACCEPTANCE WILL NOT BE MADE UNTIL ALL DAMAGED AREAS HAVE BEEN REPAIRED.

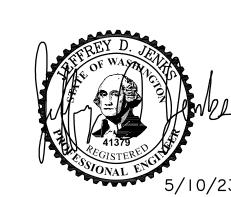

CALL 48 HOURS
BEFORE YOU DIG
811

NOTE: |- L |- |

IF "L" DOES NOT MEASURE 1"

ADJUST SCALES ACCORDINGLY.

NO IN SHARE


728 134th Street SW · Su Everett, Washington 9820 Ph: 425 741—3800

KAGIT FIELDS
NFRAI NOTES

DES. JDJ SHEET NO.
DR. JDJ CH. --F.B. OF SHEE


DATE 05/10/2023


NO. 21-2018-016

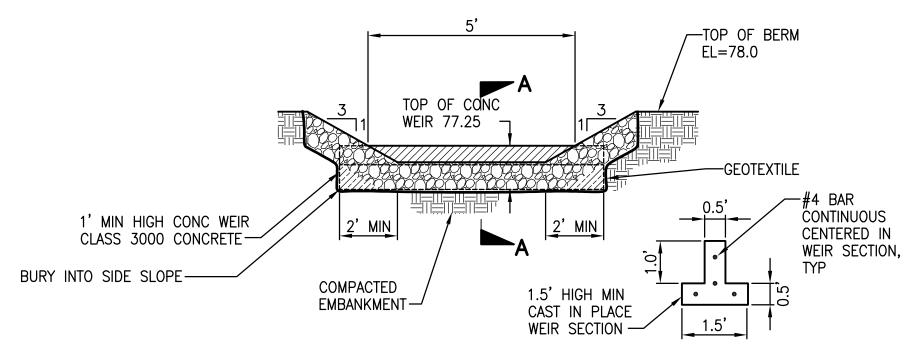


SECTION B-B NOTE: WS=WATER SURFACE

## **EMERGENCY OVERFLOW SPILLWAY** NOT TO SCALE

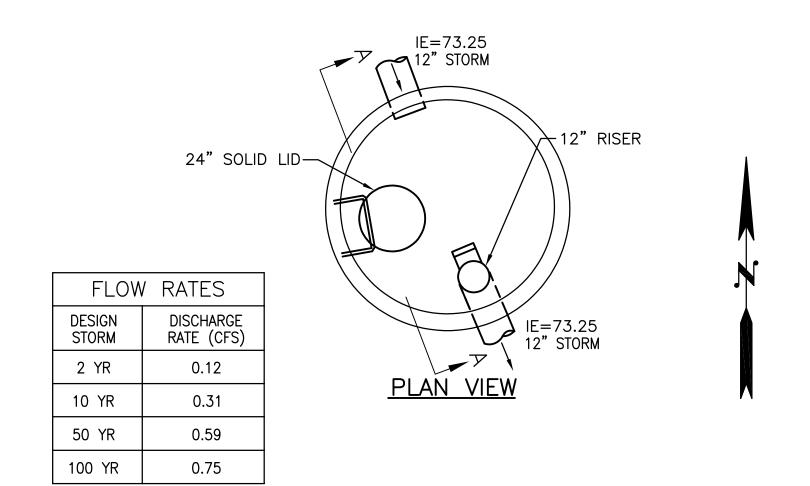


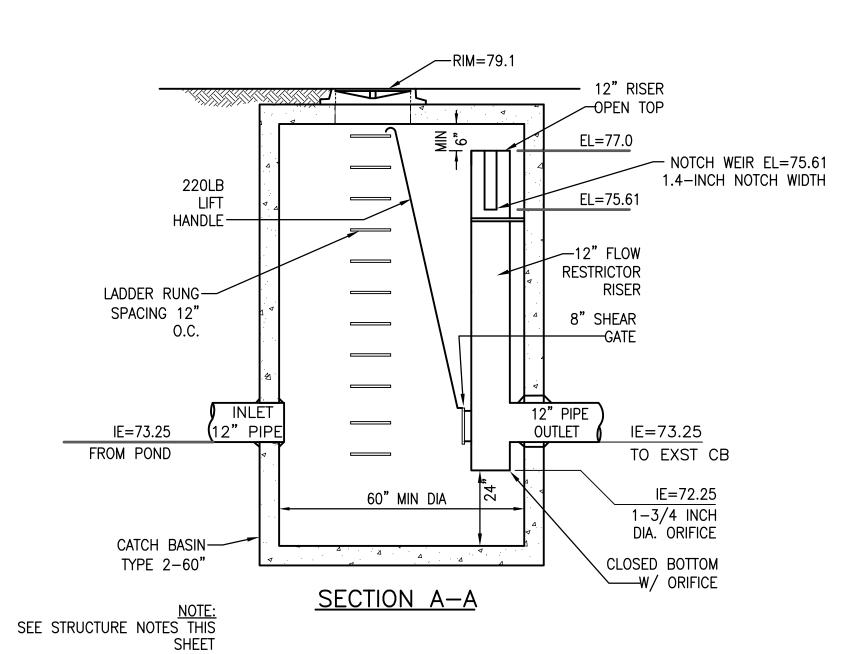

C2.1 C2.3 CS#1 CONTROL STRUCTURE NOT TO SCALE

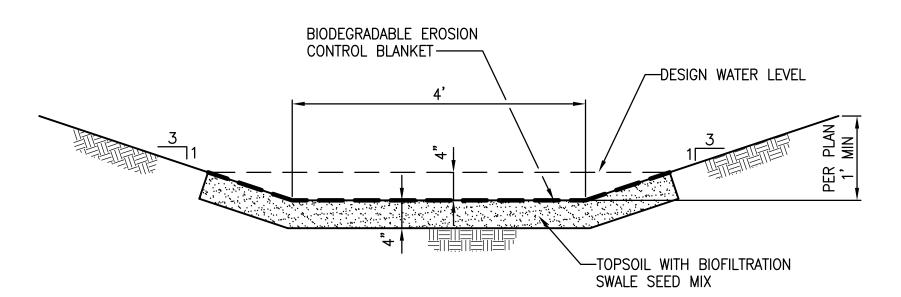


## **BIOFILTRATION SWALE** NOT TO SCALE

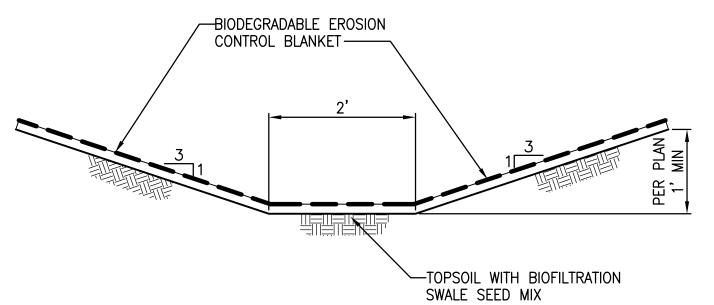

GRASS LINED SWALE NOT TO SCALE

- BIOFILTRATION SWALE SEED MIX: (120 LB/ACRE) 1.1. 75%-80% TALL OR MEADOW FESCUE 1.2. 10%-15% SEASIDE/COLONIAL BENTGRASS1.3. 5%-10% REDTOP
- 2. BIODEGRADABLE EROSION CONTROL BLANKET 2.1. PER WSDOT STANDARD SPECIFICATION SECTION 8-01.3(3) AND SECTION 9-14.6(2)


- BIOFILTRATION SWALE SEED MIX: (120 LB/ACRE) 1.1. 75%-80% TALL OR MEADOW FESCUE 1.2. 10%-15% SEASIDE/COLONIAL BENTGRASS 1.3. 5%-10% REDTOP
- 2. BIODEGRADABLE EROSION CONTROL BLANKET 2.1. PER WSDOT STANDARD SPECIFICATION SECTION 8-01.3(3) AND SECTION 9-14.6(2)

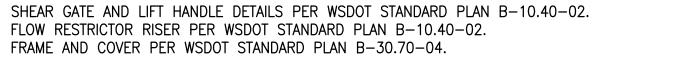

STORM DRAIN STRUCTURE NOTES

CATCH BASIN TYPE-2 PER WSDOT STANDARD PLAN B-10.20-02 AND B-10.40-02.

FRAME AND COVER PER WSDOT STANDARD PLAN B-30.70-04.

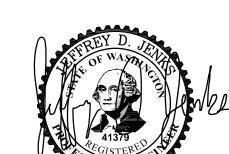


CALL 48 HOURS **BEFORE YOU DIG** 811

IF "L" DOES NOT MEASURE 1' ADJUST SCALES ACCORDINGLY.

JDJ ---

1"=40' DES. JDJ SHEET NO. OATE 05/10/2023

FILE 21-2018-016

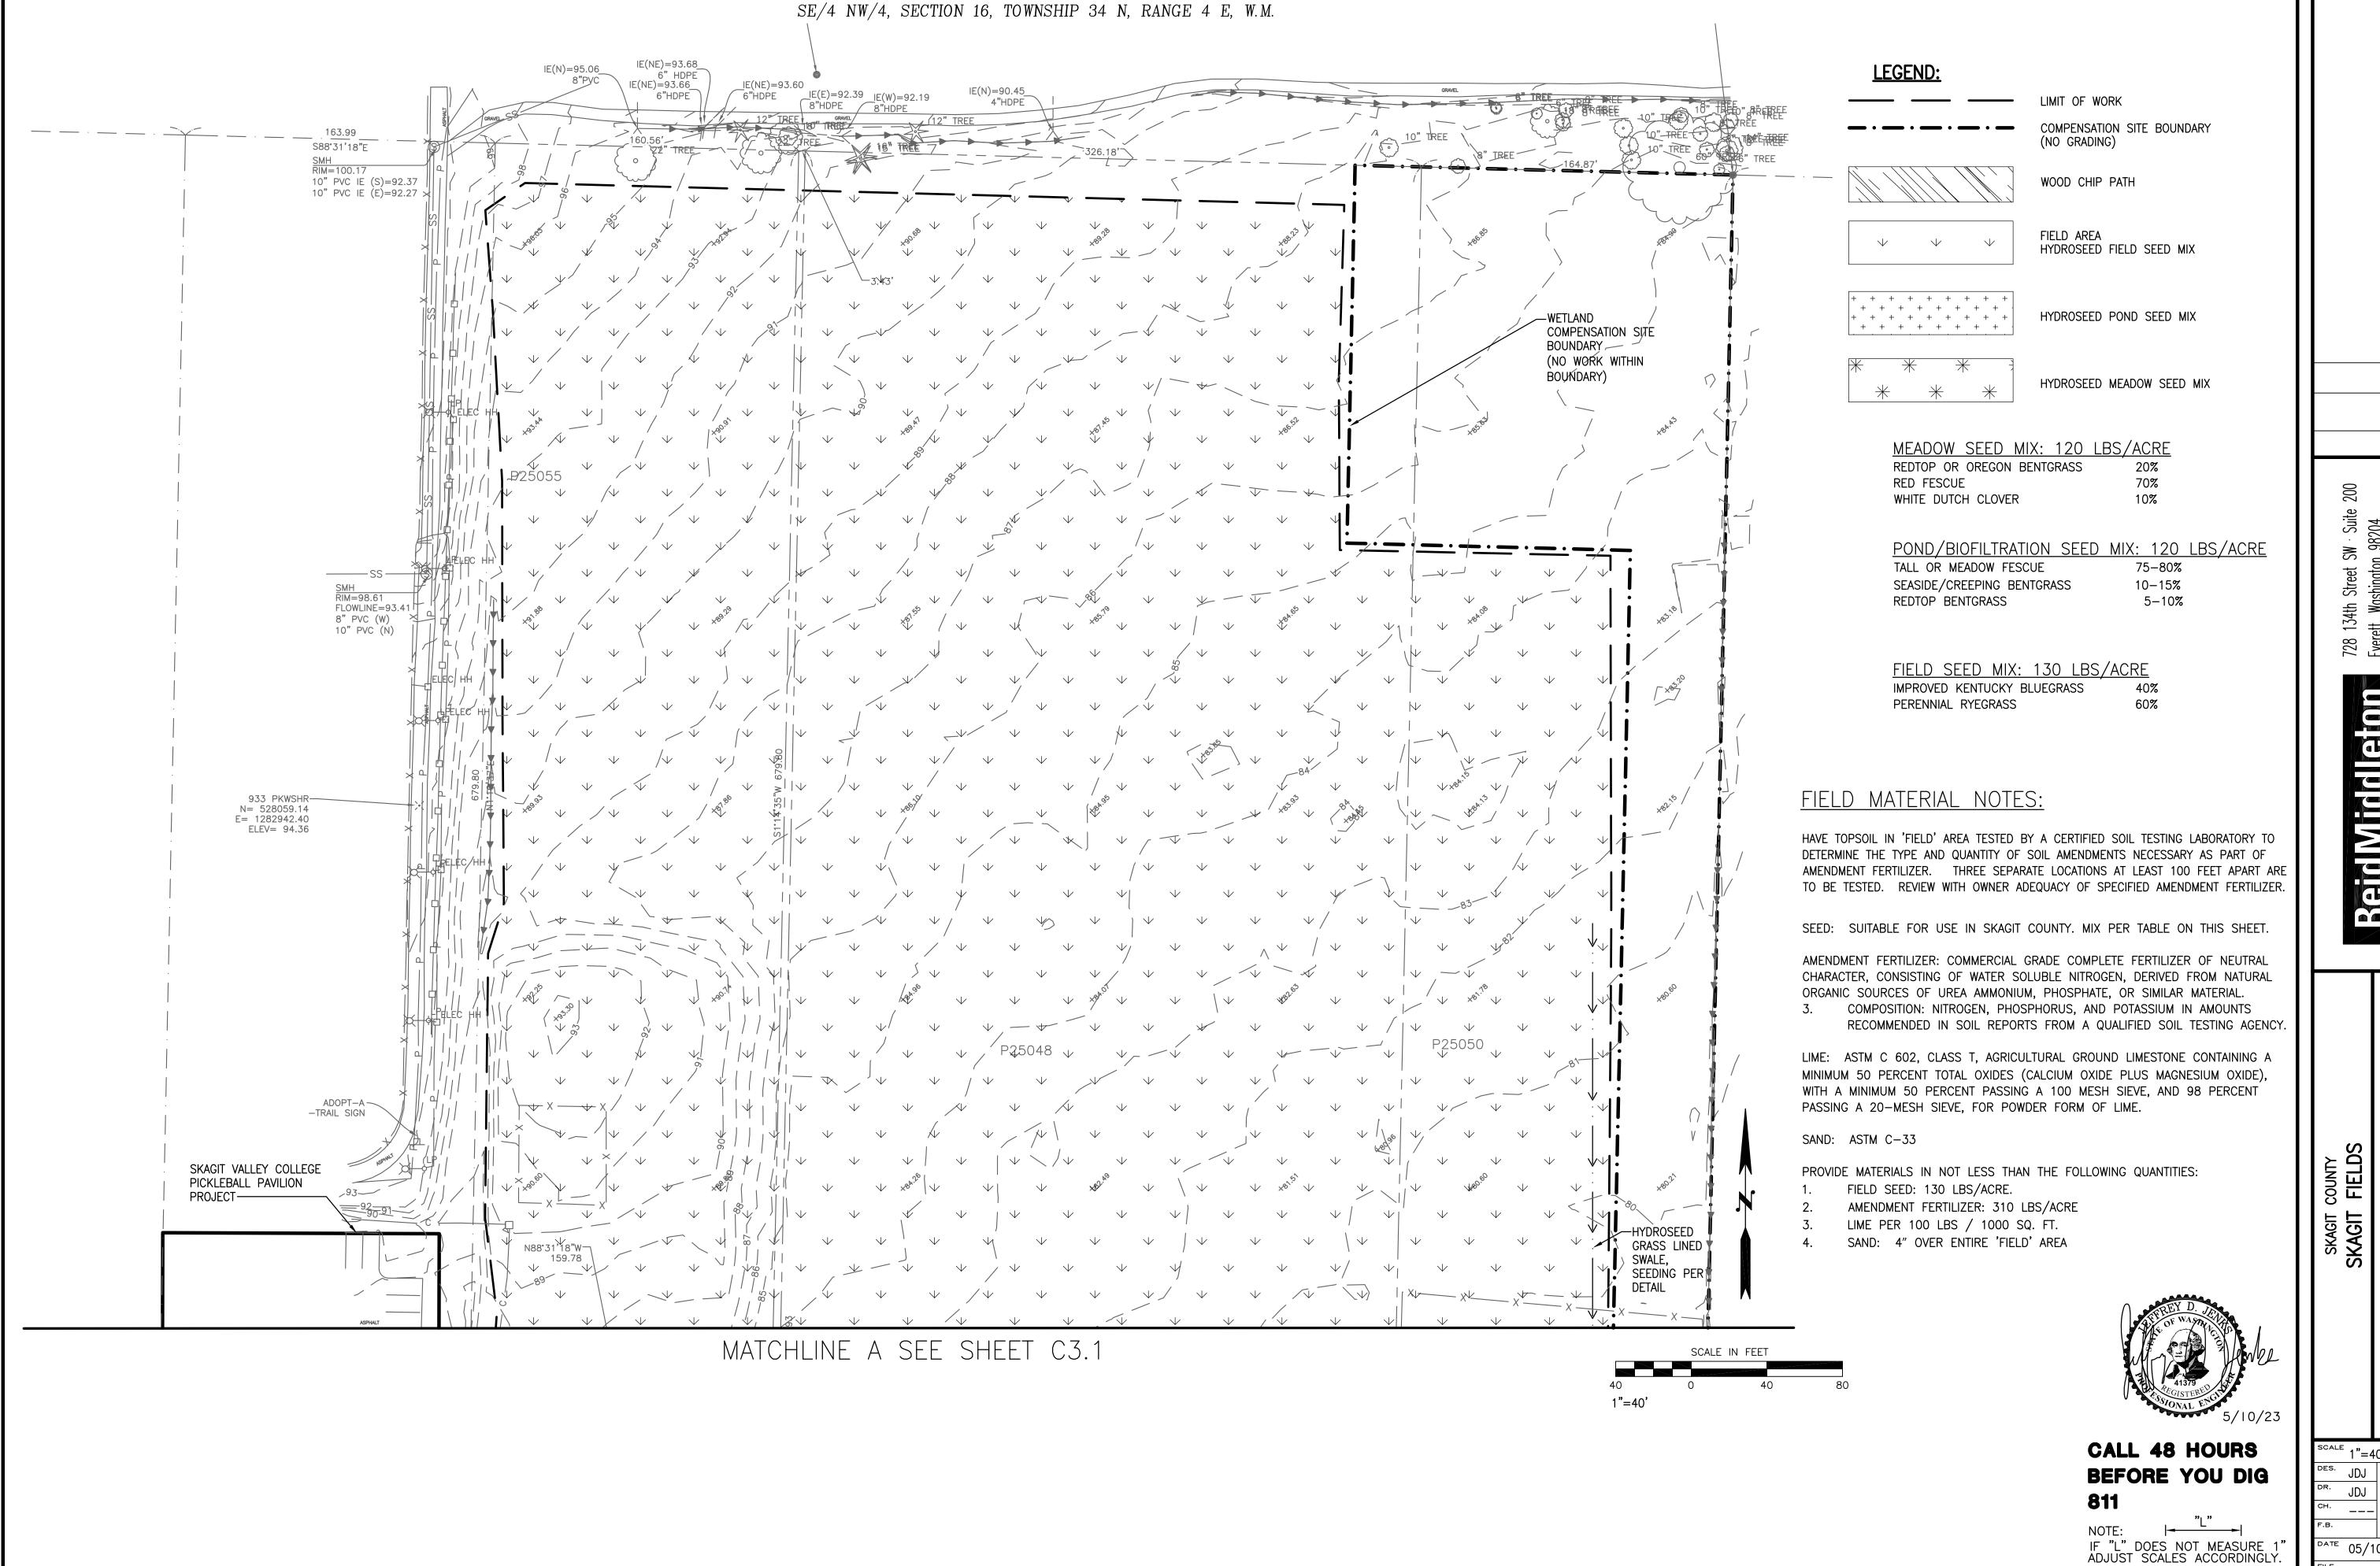

1"=40' DES. JDJ SHEET NO. O5/10/2023

FILE 21-2018-016

